

\* ALL DIMENSIONS ARE TO BE CONFIRMED BY THE BUILDER PRIOR TO CONSTRUCTION. DO NOT SCALE FROM DRAWINGS.
BUILDING SET OUT & SITE BOUNDARY DETAILS TO BE CONFIRMED BY A REGISTERED SURVEYOR.
ALL WORK TO BE CARRIED OUT TO RELEVANT STANDARDS AND BUILDING CODES.



Feels like home

DUBBO NEW SOUTH WALES

BRAD ACHESON BUILDING Pty Ltd T/A STROUD HOMES DUBBO LIC 135090c

	SCALE: 1:100 (A3)	NT	DRAWING: ELEVATIONS 14 ELEANOR DARK COURT, MUDGEE
SHEET:	JOB No:		HELEN HINDMARSH

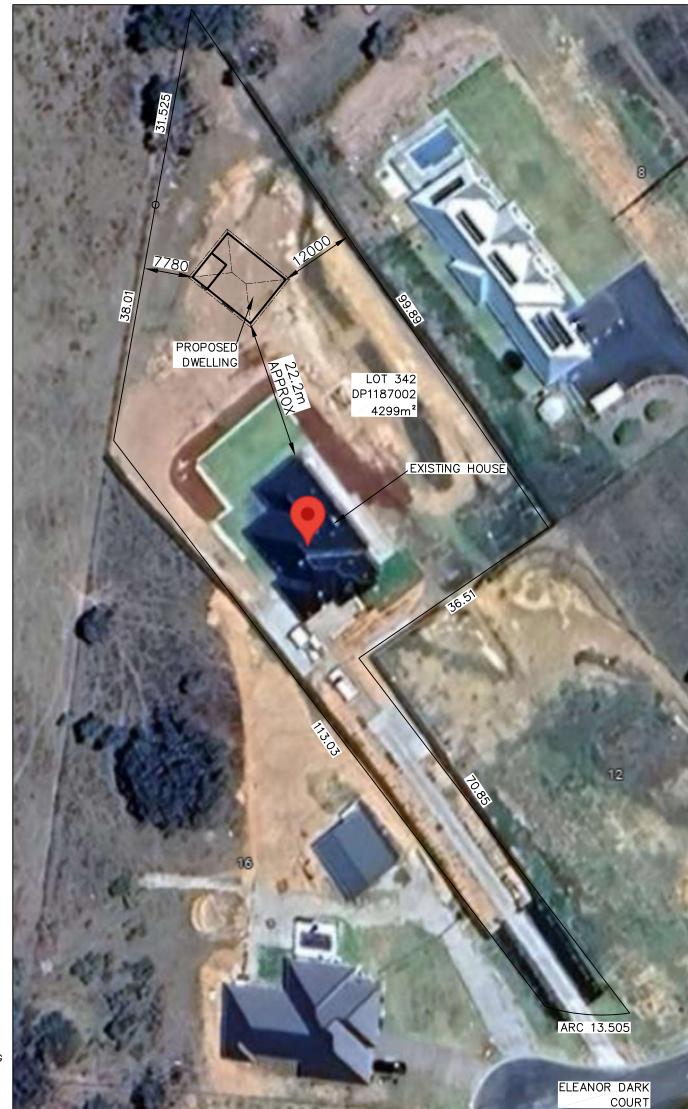
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2 / 5

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 $\ensuremath{^{\star}}$  The Proposed residence slab is to be constructed

ON A LEVEL BUILDING PAD PREPARED IN ACCORDANCE WITH
THE STRUCTURAL ENGINEER'S SPECIFICATIONS.
THE MAIN FINISHED FLOOR LEVEL IS TO BE SET

300mm ABOVE THE CONSTRUCTION PAD LEVEL. FINISHED SURFACE LEVELS ARE TO GRADE AWAY

BUILDING PERIMETER TO PREVENT WATER PONDING NEAR EXTERNAL WALLS WITHOUT BEING DETRIMENTAL TO NEIGHBOURING PROPERTIES. THE BUILDER IS TO CONFIRM AVAILABLE FALLS TO SEWER

CONNECTION POINTS & STORMWATER DISCHARGE POINTS
PRIOR TO ESTABLISHING THE BUILDING FINISHED FLOOR LEVEL.



DUBBO NEW SOUTH WALES

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\* ALL SURFACE LEVELS AND FEATURE LOCATIONS ARE TO BE CONFIRMED PRIOR TO CONSTRUCTION

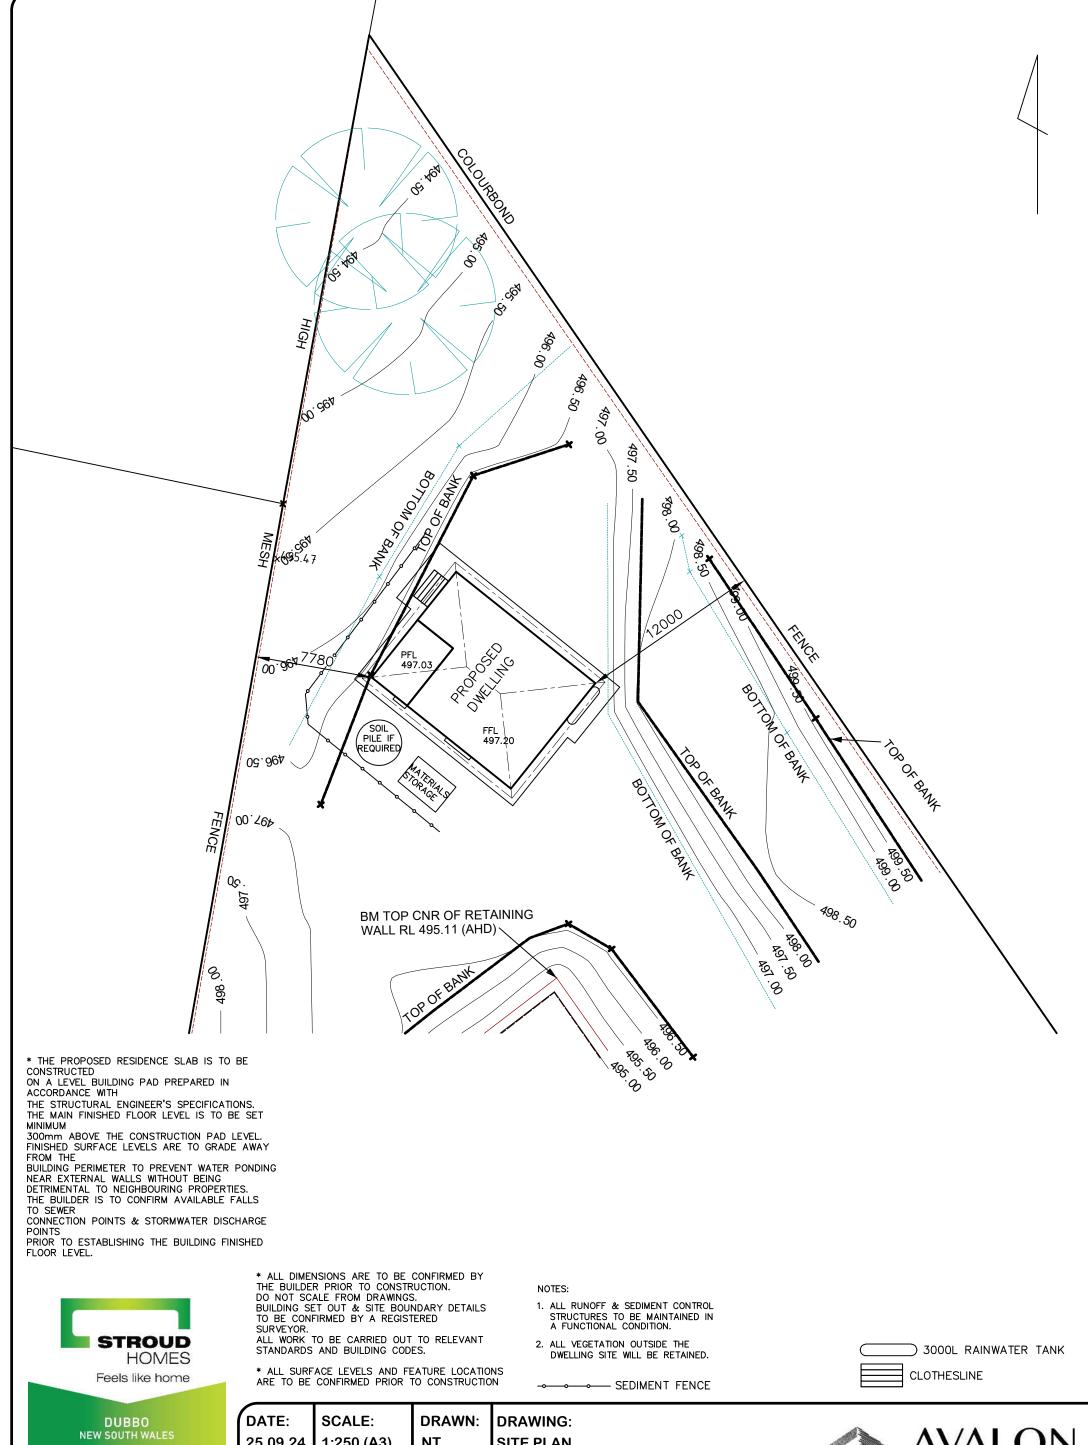
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3 / 5

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	SCALE: 1:600 (A3)	NT	DRAWING: SITE PLAN 14 ELEANOR DARK COURT, MUDGEE
SHEET:	JOB No:	ISSUE:	HELEN HINDMARSH





DATE: SCALE: DRAWN: DRAWING:
25.09.24 1:250 (A3) NT SITE PLAN
14 ELEANOR DARK COURT, MUDGEE
SHEET: JOB No: ISSUE: HELEN HINDMARSH

**BRAD ACHESON BUILDING Pty Ltd** 

T/A STROUD HOMES DUBBO

LIC 135090c

4 / 5

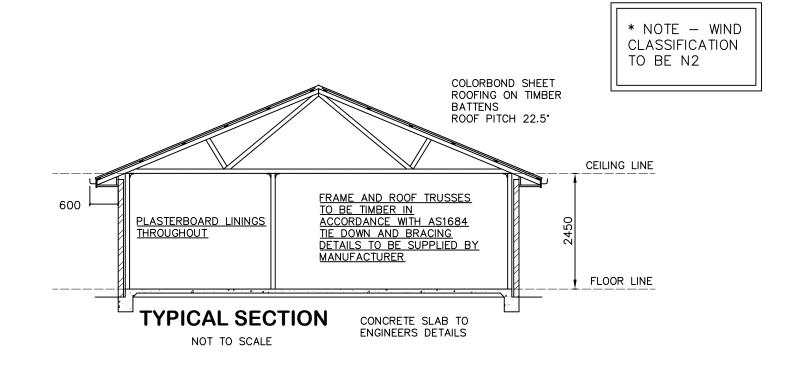
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BASIX C	BASIX COMMITMENTS						
WATER COMMITMENTS LANDSCAPE AREA LOW WATER USE SPECIES OF VEGETATION FIXTURES SHOWER HEAD RATING TOILET FLUSHING SYSTEM RATING KITCHEN TAPS BASIN TAPS ALTERNATIVE WATER RAINWAITER TANK RAINWAITER TANK RAINWAITER TANK CAPACITY ROOF COLLECTION AREA FOR R/W  R/W TANK CONNECTED TO			MIN RATI 4 ST 5 ST 5 ST 3000 LT 100 SQ. MIN 1 N ALL TOIL	MIN RATING 4 STAR 4 STAR 5 STAR 5 STAR 5 STAR 3000 LITRE 100 SQ.M. MIN 1 No. OUTDOOR TAP ALL TOILETS IN DWELLING THE COLD WATER TAP THAT SUPPLIES THE CLOTHES WASHER			
GENERAL F	THERMAL COMFORT COMMITMENTS GENERAL REQUIREMENTS —  CLASS 1 DWELLING WITH NOT MORE THAN 2 STOREYS CONDITIONED FLOOR AREA NOT EXCEEDING 300 SQUARE METRES MUST NOT HAVE OPEN MEZZANINE OF MORE THAN 25 SQUARE METRES NOT CONTAIN THIRD LEVEL HABITABLE ATTIC ROOM						
GROUND FLOOR CONSTRUCTION EXTERNAL WALL CEILING AND ROOF  CONCRETE SLAB ON GROUND BRICK VENEER - R2.60 INC CONSTRUCTION FLAT CEILING/PITCHED ROOF - CEILING R4, ROOF - SARKING - UNVENTILATED - DARK (SOLAR ABSORPTANCE > 0.7)							
WINDOW	OMFORT COMMITMEN ORIENTATION	MAXIMUM HEIGHT (mm)	MAXIMUM WIDTH (mm)	ТҮРЕ	SHADING	OVERSHADOWING	
W01	NE	600	2700	ALUMINIUM, SINGLE, CLEAR	EAVE 600mm, 0mm ABOVE HEAD OF WINDOW OR GLAZED DOOR	NOT OVERSHADOWED	
W02	NE	600	2100	ALUMINIUM, SINGLE, CLEAR	EAVE 600mm, 0mm ABOVE HEAD OF WINDOW OR GLAZED DOOR	NOT OVERSHADOWED	
W03	NE	600	1800	ALUMINIUM, SINGLE, CLEAR	EAVE 600mm, 0mm ABOVE HEAD OF WINDOW OR GLAZED DOOR	NOT OVERSHADOWED	
W04	SE	400	900	ALUMINIUM, SINGLE, CLEAR	EAVE 600mm, 0mm ABOVE HEAD OF WINDOW OR GLAZED DOOR	NOT OVERSHADOWED	
W05	SW	2100	4200	ALUMINIUM, SINGLE, CLEAR	EAVE 600mm, 140mm ABOVE HEAD OF WINDOW OR GLAZED DOOR	NOT OVERSHADOWED	
W06	NW	2100	3600	ALUMINIUM, SINGLE, CLEAR	EAVE 3600mm, 140mm ABOVE HEAD OF WINDOW OR GLAZED DOOR	NOT OVERSHADOWED	
ENERGY COMMITMENTS HOT WATER SYSTEM COOLING SYSTEM HEATING SYSTEM HEATING SYSTEM PETRICAL VENTILATION BATHROOM KITCHEN LAUNDRY  EXTRACT FAN DUCTED TO ROOF OR FACADE — MANUAL ON/OFF LAUNDRY NATURAL VENTILATION ONLY  EXTRACT FAN DUCTED TO ROOF OR FACADE — MANUAL ON/OFF NATURAL VENTILATION ONLY  REVERSE CYCLE: EER 3.0—3.5 WITH DAY/NIGHT ZONING BETWEEN LIVING/BED AREAS  HEVERSE CYCLE: EER 3.0—3.5 WITH DAY/NIGHT ZONING BETWEEN LIVING/BED AREAS  HEVERSE CYCLE: EER 3.0—3.5							
ARTIFICIAL LIGHTING KITCHEN BATHROOMS/TOILETS LAUNDRY HALLWAYS LVING AREAS BEDROOMS  PRIMARY TYPE OF ARTIFICIAL LIGHTING IS FLUORESCENT OR LIGHT EMITTING DIODE (LED) PRIMARY TYPE OF ARTIFICIAL LIGHTING IS FLUORESCENT OR LIGHT EMITTING DIODE (LED) PRIMARY TYPE OF ARTIFICIAL LIGHTING IS FLUORESCENT OR LIGHT EMITTING DIODE (LED) LVING AREAS BEDROOMS  PRIMARY TYPE OF ARTIFICIAL LIGHTING IS FLUORESCENT OR LIGHT EMITTING DIODE (LED) X 2 PRIMARY TYPE OF ARTIFICIAL LIGHTING IS FLUORESCENT OR LIGHT EMITTING DIODE (LED) X 3							
KITCHEN	NATURAL LIGHTING KITCHEN WINDOW BATHROOMS/TOILETS WINDOW x 1						
APPLIANCE KITCHEN REFRIGERA CLOTHES I	ator space   Well ventilated as basix definition						

These are the specifications upon which the Basix assessment is based. These specifications take precedence over the drawings or other specifications.



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ON A LEVEL BUILDING PAD PREPARED IN ACCORDANCE WITH
THE STRUCTURAL ENGINEER'S SPECIFICATIONS.
THE MAIN FINISHED FLOOR LEVEL IS TO BE SET MINIMUM
300mm ABOVE THE CONSTRUCTION PAD LEVEL.
FINISHED SURFACE LEVELS ARE TO GRADE AWAY FROM THE
BUILDING PERIMETER TO PREVENT WATER PONDING NEAR EXTERNAL WALLS WITHOUT BEING DETRIMENTAL TO NEIGHBOURING PROPERTIES.
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Feels like home

HOMES

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DATE:	SCALE:	DRAWN:	DRAWING:
25.09.24	N/A	NT	BASIX COMMITMENTS & TYP SECTION
			14 ELEANOR DARK COURT, MUDGEE
SHEET:	JOB No:	ISSUE:	HELEN HINDMARSH

