





## **GENERAL NOTES**

PLANS DOCUMENTED FOR THE EXCLUSIVE USE OF THE NOTED CLIENTS BELOW ONLY AND ARE SUBJECT TO COPYRIGHT LAWS

ALL DRAWINGS SHALL BE READ IN CONJUNCTION WITH - ALL SHEETS TO THIS SET OF PLANS, INCLUDING BASIX CERT. - ALL ARCHITECTURAL & OTHER CONSULTANTS DRAWINGS & SPECIFICATIONS & WITH SUCH OTHER WRITTEN INSTRUCTIONS AS MAY BE ISSUED DURING THE COURSE OF THE CONTRACT - ALL RELEVANT CODES, STANDARDS & APPROVALS.

FIGURED DIMENSIONS ARE TO BE TAKEN IN PREFERENCE TO SCALED DIMENSIONS. ALL DIMENSIONS ARE TO STRUCTURAL ELEMENTS AND DO NOT INCLUDE FINISHED SURFACES SUCH AS PLASTERBOARD, TILING ETC. ALL DIMENSIONS RELEVANT TO SETTING OUT & OFF-SITE WORK SHALL BE VERIFIED BY THE CONTRACTOR BEFORE CONSTRUCTION & FABRICATION.

ANY DISCREPANCIES SHALL BE REFERRED TO EVOLVE BUILDING DESIGN BEFORE PROCEEDING

ALL DIMENSIONS ARE IN MILLIMETRES UNLESS STATED OTHERWISE & LEVELS ARE EXPRESSED IN METRES.

PRIOR TO CONSTRUCTION ALL LEVELS, DIMENSIONS, SITE CONDITIONS & SERVICES SHALL BE CHECKED & CONFIRMED ON SITE

WORKMANSHIP & MATERIALS ARE TO BE IN ACCORDANCE WITH THE RELEVANT CURRENT S.A.A CODES INCLUDING ALL AMENDMENTS, THE 'BUILDING CODE OF AUSTRALIA - VOLUME 2, 2016 '; POLICY REQUIREMENTS OF 'MID WESTERN REGIONAL COUNCIL';

THE RELEVANT SERVICE AND STATUTORY AUTHORITIES SHALL BE NOTIFIED IN ADVANCE & THEIR APPROVALS OR SERVICES, IF NECESSARY SHALL BE OBTAINED

## **CONSTRUCTION NOTES**

SITE CLASSIFICATION TO BE DETERMINED BY QUALIFED GEOTECHNICAL ENGINEER AND AND ALL REINGORCED CONCRETE FOOTINGS AND SLARS TO BE COMNSTRUCTED TO AS2870.

SHALL NO WIND CLASSIFICATION BE NOTED, CLIENT TO BE ADVISED BY PCA OR ENGINEERING CONSULTANT

STUD WALL, ROOF TRUSS DESIGN, WALL FRAME BRACING, ROOF BRACING, & ALL 'TIE DOWN' FIXING DETAILS TO BE AS SPECIFIED & DETAILED BY TRUSS/FRAME MANUFACTURER AND TO AS1684 WHERE APPLICABLE

WET AREAS OF THE BUILDING IE. NEW BATHROOMS ARE TO BE PROTECTED BY THE INSTALLATION OF A WATER PROOFING SYSTEM COMPLYING WITH AS3740 - "WATERPROOFING OF WET AREAS"

ALL STORMWATER FROM ROOF TO BE COLLECTED BY EAVES GUTTER & DISCHARGED THUR DOWNPIPES TO RAIN WATER TANKS & STREET WHERE REQUIRED, OVERFLOW TO BE DETERMINED ON SITE

WATER TEMPERATURE TO ALL OUTLETS ( EXCEPT LAUNDRY & KITCHEN ) NOT TO EXCEED 50°C

THE BUILDING IS TO BE PROTECTED AGAINST SUBTERRANEAN TERMITES, IN ACCORDANCE WITH 'AS. 3660'

ALL PLUMBING WORKS ARE TO BE IN ACCORDANCE WITH THE PLUMBING CODE OF AUSTRALIA (PCA), THE NEW SOUTH WALES CODE OF PRACTICE FOR PLUMBING & DRAINAGE 2006 (NSW PLUMBING CODE) & AS/NZS3500

A MINIMUM WATER ALLOWANCE SHALL BE PROVIDED FOR RURAL PROPERTIES FOR FIRE RIGHTING PURPOSES AS SPECIFIED BY PCA


SEWER DRAINAGE LINES TO BE CONNECTED TO SEWER MAIN OR IN THE CASE OF A RURAL PROPERTY, CONECTED TO A SEPTIC SYSTEM, IN ACCORDANCE WITH THE RELEVANT AUSTRALIAN STANDARDS AND LOCAL

WHERE BRICK VENEER CONSTRUCTION IS SPECIFIED, CONTROL JOINTS FOR ARTICULATION MUST BE PROVIDED TO STRUCTURAL ENGINEERS DETAILS

IF SITE REQUIRES CUT AND FILL TO OCCUR OR RETAINING WALLS CONSTRUCTED. ENGINEERS SHALL BE CONSULTED WHERE NECESSARY & CONTRACTOR SHALL ENSURE ANY SURFACE STORMWATER BE DIVERTED FROM PROPOSED RESIDENCE APPROPRIATELY. NEIGHBOURING PROPERTIES SHALL BE TAKEN INTO

# PROPOSED NEW RESIDENCE

# THE CLAYPOLE PAVILIONS 43 LECONFIELD DRIVE, BOMBIRA NSW

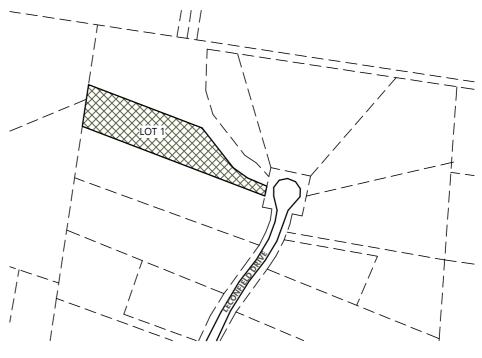

LOCATION PLAN NOT TO SCALE



## DRAWING SCHEDULE

00031 01 LOCATION PLAN & 3D PERSPECTIVES

00031 02 SITE PLAN & NOTES

00031 03 CUT & FILL PLAN

00031 04 PART SITE PLAN - STAGE 1

00031 05 FLOOR PLAN DIMENSIONS

00031 06 FLOOR LAYOUT NOTES & OPENINGS

00031 07 ELEVATIONS 1/2

00031 08 ELEVATIONS 2/2

00031 09 DOOR + WINDOW SCHEDULES

00031 10 SECTION & BASIX SCHEDULE

00031 11 HOUSE SLAB SETOUT

00031 12 SCNDRY DWELLING FLOOR PLAN & BASIX SCHEDULE

00031 13 SCNDRY DWELLING ELEVATIONS

14 DETACHED GARAGE SITE & FLOOR PLANS - STAGE 2

00031 15 DETACHED GARAGE ELEVATIONS

00031 16 CONSTRUCTION DETAILS

00031 17 SAFE DESIGN OF STRUCTURES NOTES



## **EVOLVE BUILDING DESIGN**

ABN: 54 600 658 311 Mudgee NSW 2850

0421 270 486 evolvebd@outlook.com

CLIENT: AMY & DAN CLAYPOLE

PROJECT No: 00031

PROJECT: PROPOSED RESIDENCE 43 LECONFIELD DRIVE BOMBIRA

DRAWING TITLE: LOCATION PLAN & 3D PERSPECTIVES

DRAWING No: 01 of 17 REVISION: 5


REVISION DATE

DESCRIPTION

28.05.2024 ISSUE FOR CLIENT REVIEW 29.07.2024 DA FOR CLIENT REVIEW 12.10.2024 WINDOW CHANGES & ADD

BLDS 13.11.2024 ISSUE FOR DA/CC

02.12.2024 ADD. INFO - ISSUE DA/CO

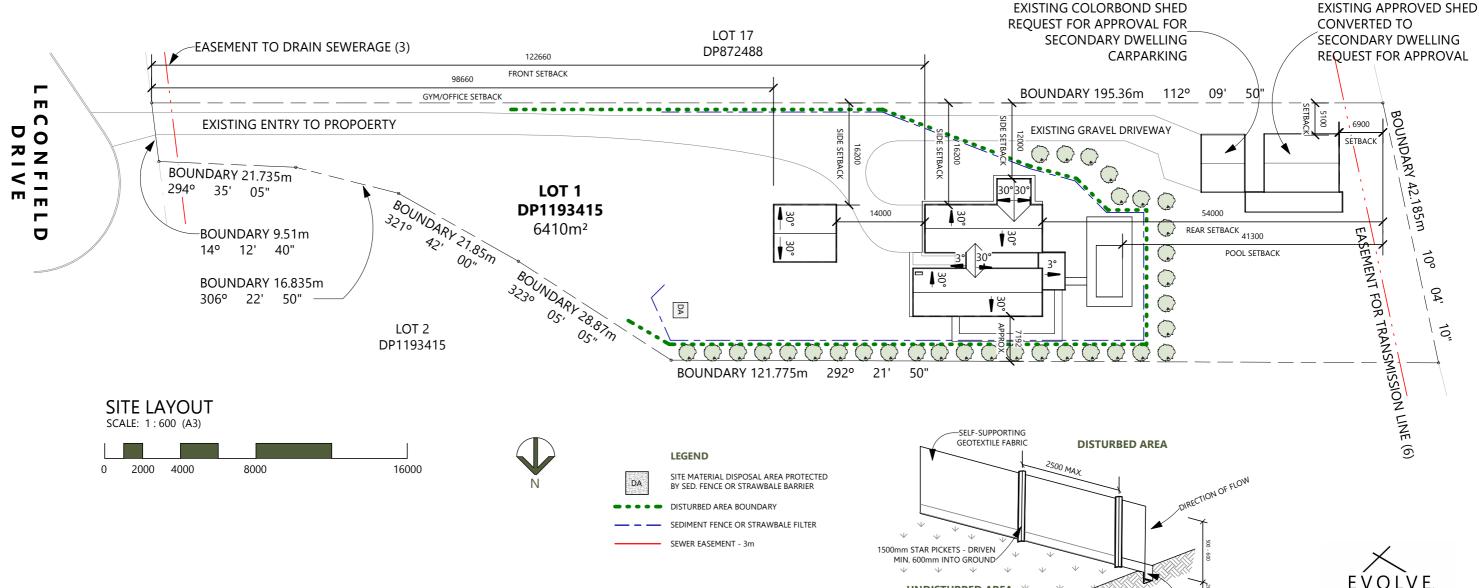

## **SITE NOTES**

CONFIRM ALL DIMENSIONS ON SITE PRIOR TO COMMENCEMENT OF ANY WORK. THIS PLAN HAS BEEN PREPARED FROM A COMBINATION OF EXISTING RECORDS AND FIELD SURVEY FOR THE PURPOSE OF DESIGNING NEW CONSTRUCTIONS AND SHOULD NOT BE USED FOR ANY OTHER PURPOSE. TILTLE BOUNDARIES HAVE BEEN DETERMINED BY PLAN DIMENSIONS ONLY

THE EXACT LOCATION OF ABOVEGROUND AND UNDERGROUND SERVICES SHALL BE PROVEN ONSITE. ALL EXISTING SERVICES ARE NOT GUARANTEED TO BE SHOWN ON

PRIOR TO ANY DEMOLITION, EXCAVATION OR CONSTRUCTION ON THE SITE, THE RELEVANT AUTHORITY SHOULD BE CONTACTED FOR POSSIBLE LOCATION OF FURTHER UNDERGROUND SERVICES & DETAILED LOCATIONS OF ALL SERVICES

SUBSEQUENT REGISTERED OR OTHER SURVEYS IN THIS AREA MAY AFFECT THE BOUNDARY DEFINITION SHOWN ON THIS PLAN. ANY DIFFERENCES SO CAUSED TO THE BOUNDARY DEFINITION SHOWN ON THIS PLAN ARE BEYOND THE CONTROL OF EVOLVE BUILDING DESIGN WHO CAN ACCEPT NO RESPONSIBILITY FOR SUCH

ALL WORK TO BE UNDERTAKEN IN ACCORDANCE WITH THE DETAILS SHOWN & THE DIRECTIONS OF THE BUILDER. CONTRACTORS MUST VERIFY ALL DIMENSIONS &EXISTING LEVELS ON SITE PRIOR TO COMMENCEMENT OF WORK

THE BUILDER SHALL ARRANGE ALL SURVEY SETOUT TO BE CARRIED OUT BY A

THIS PLAN DOES NOT PROVDIE SPECIFIC LANDSCAPE PLANTING LOCATIONS,

## **EROSION & SEDIMENT CONTROL NOTES**

ALL EROSION & SEDIMENT CONTROL STRUCTURES ARE TO BE INSTALLED PRIOR TO SITE DISTURBANCE.

ALL SEDIMENT CONTROL STRUCTURES TO BE INSPECTED & MAINTAINED BY THE BUILDER. IF STRUCTURES ARE TEMPORARILY REQUIRED TO BE REMOVED, THEY SHALL BE REINSTALLED & INSPECTED BY THE BUILDER.

ALL SEDIMENT RETAINING STRUCTURES TO BE CLEANED ON REACHING 50% STORAGE CAPACITY & SPREAD ON DISTURBED AREA

ACCESS TO SITE IS TO BE THROUGH USE OF THE ENTRY/EXIT SHOWN


ALL VEGETATION OUTSIDE OF THE CONSTRUCTION AREA IS TO BE RETAINED WHERE

THE PROJECT MANAGER IS TO INFORM ALL CONTRACTORS OF THEIR OBLIGATIONS

ALL SEWER, WATER & DRAINAGE LINE TRENCHES ARE TO BE BACKFILLED WITHIN 24 HOURS OF INSPECTION & APPROVAL

STOCKPILES OF ERODIBLE BUILDING MATERIALS INCLUDING SAND & SOIL MUST BE LOCATED WITHIN THE DESIGNATED MATERIAL STOCKPILE AREA (MSA) & PROTECTED WITH SEDIMENT FENCE OR STRAW BALE SEDIMENT FILTERS. THE BUILDER MAY NOMINATE FURTHER STORAGE AREAS WITHIN THE SITE

NO STORAGE OF MATERIALS OR VECHICLE MOVEMENTS ARE TO OCCUR OUTSIDE THE SITE BOUNDARIES

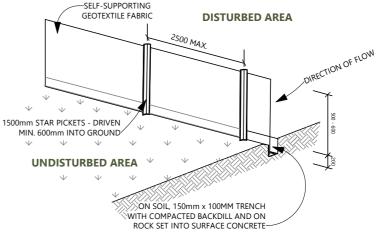

## **DETAIL PLAN: SEDIMENT FENCE** NOT TO SCALE

CONSTRUCT SEDIMENT FENCES AS CLOSE AS POSSIBLE TO BEING PARALLEL TO THE CONTOURS OF THE SITE, BUT WITH SMALL RETURNS TO LIMIT WATER FLOW IF CONCENTRATED AT ONE POINT TO 50L PER SECOND.

CUT A 150mm DEEP TRENCH ALONG THE UPSLOPE LINE OF THE FENCE FOR THE

DRIVE 1500mm STAR PICKETS MIN. 600mm INTO GROUND AT MAX. 2500mm INTERVALS AT DOWNSIDE OF TRENCH, ENSURE STAR PICKETS ARE FITTED WITH SAFETY CAPS.

FIX SELF-SUPPORTING GEOTEXTILE TO THE UPSLOPE SIDE OF THE POSTS ENSURING IT GOES INTO THE BASE OF THE TRENCH. FIX THE GEOTEXTILE FABRIC AS RECOMMENDED BY MANUFACTURER

JOIN SECTIONS OF FABRIC AT A SUPPORT POST WITH 150mm OVERLAP BACKFIL TRENCH OVER THE BASE OF THE GAVRIC AND COMPACT IT THOROUGHLY OVER GEOTEXTILE.

ONLY USE GEOTEXTILE SPECIFICALLY PRODUCED FOR SEDIMENT FENCING SHADE CLOTH IS NOT STATISFACTORY



## **EVOLVE BUILDING DESIGN**

ABN: 54 600 658 311 Mudgee NSW 2850 0421 270 486 evolvebd@outlook.com

CLIENT: AMY & DAN CLAYPOLE

PROJECT No: 00031

PROJECT: PROPOSED RESIDENCE 43 LECONFIELD DRIVE BOMBIRA

DRAWING TITLE: SITE PLAN & NOTES


DRAWING No: 02 of 17 REVISION: 5

DESCRIPTION REVISION DATE 28.05.2024 ISSUE FOR CLIENT REVIEW 29.07.2024 DA FOR CLIENT REVIEW


12.10.2024 WINDOW CHANGES & ADD

13.11.2024 ISSUE FOR DA/CC

02.12.2024 ADD. INFO - ISSUE DA/CO

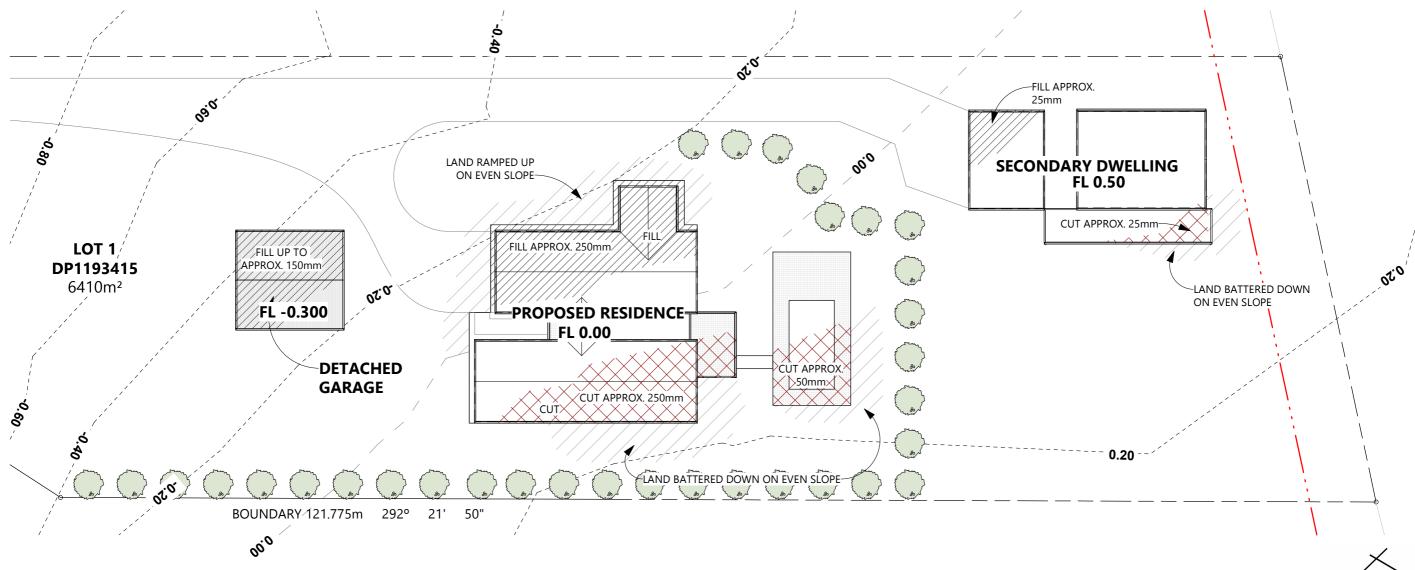

# PART SITE LAYOUT - CUT & FILL

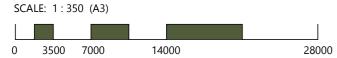

# EVOLVE BUILDING DESIGN

## EVOLVE BUILDING DESIGN

ABN: 54 600 658 311 Mudgee NSW 2850 0421 270 486 evolvebd@outlook.com

CLIENT: AMY & DAN CLAYPOLE

PROJECT No: 00031

PROJECT: PROPOSED RESIDENCE 43 LECONFIELD DRIVE BOMBIRA

DRAWING TITLE: CUT & FILL PLAN

DRAWING No: 03 of 17 REVISION: 5


REVISION:

REVISION DATE DESCRIPTION
5 02.12.2024 ADD. INFO - ISSUE DA/CC

All dimensions are in millimetres unless otherwise noted shall be checked prior to the commencement of any wor purchase or ordering of any materials, fittings, plant, ser or equipment and the preparation of shop drawings and the fabrication of any components. Immediately contact leads to the property of the property of the property of the purchase within the property of the property of the purchase within the property of propert


This drawing is to be read in conjunction with genbuilding drawings, specifications and other consul-


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-DENOTES EXISTING TREES TO BE MAINTAINED
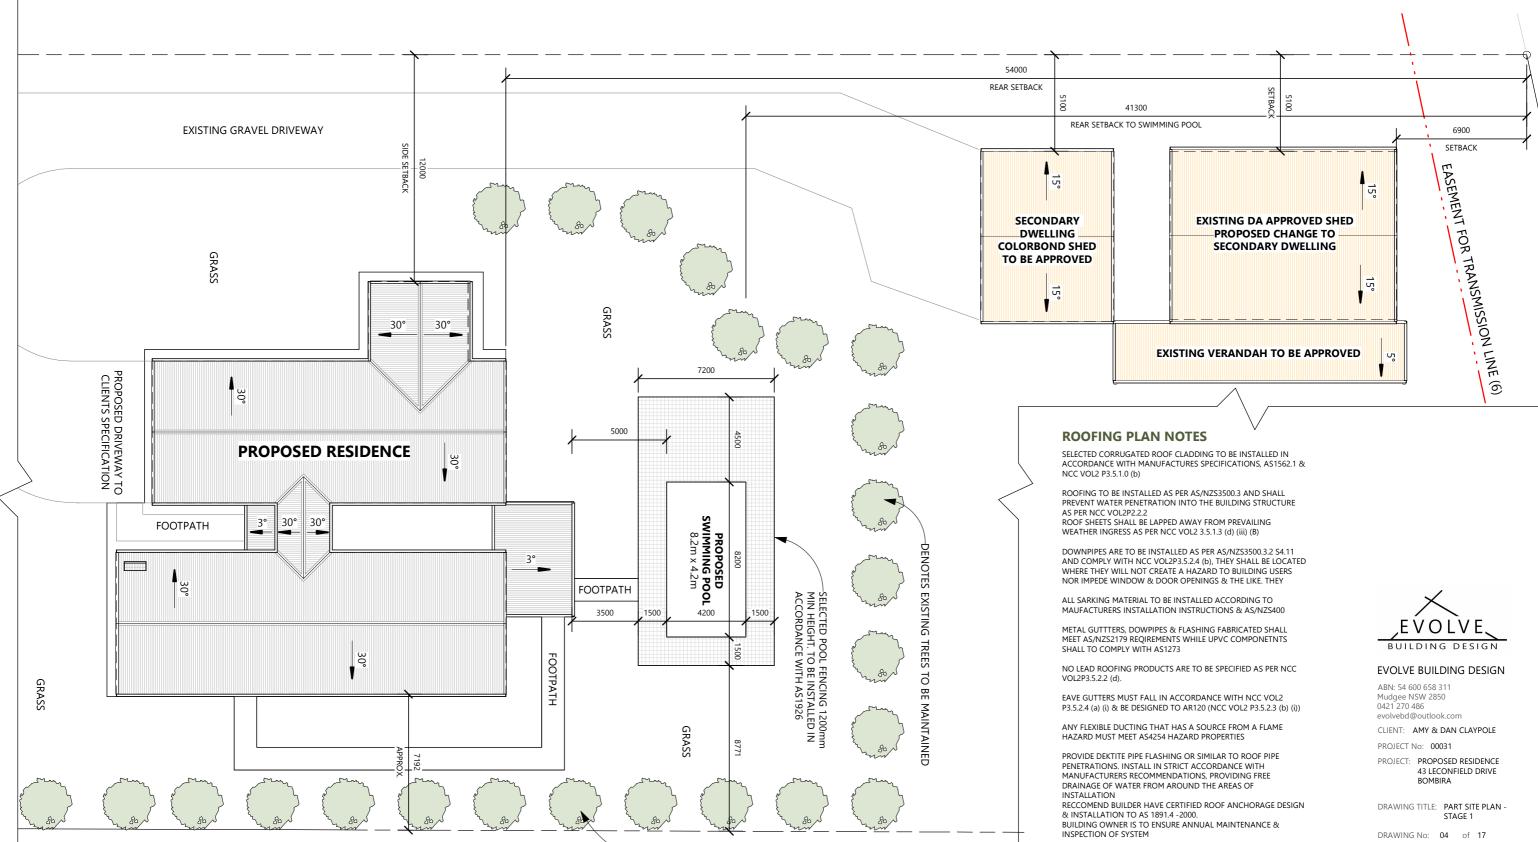
## PART SITE LAYOUT - STAGE 1



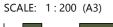

REVISION: 5

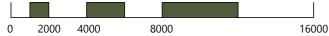BUILDER TO REFER TO TRUSSED ROOF BRACING NOMINATED BY

ROOF TRUSSES TO BE DESIGNED & INSTALLED IN ACCORDANCE


THE TRUSS MANUFACTURER

REVISION DATE DESCRIPTION

28.05.2024 ISSUE FOR CLIENT REVIEW 29.07.2024 DA FOR CLIENT REVIEW

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ISSUED DA/CC

EVOLVE

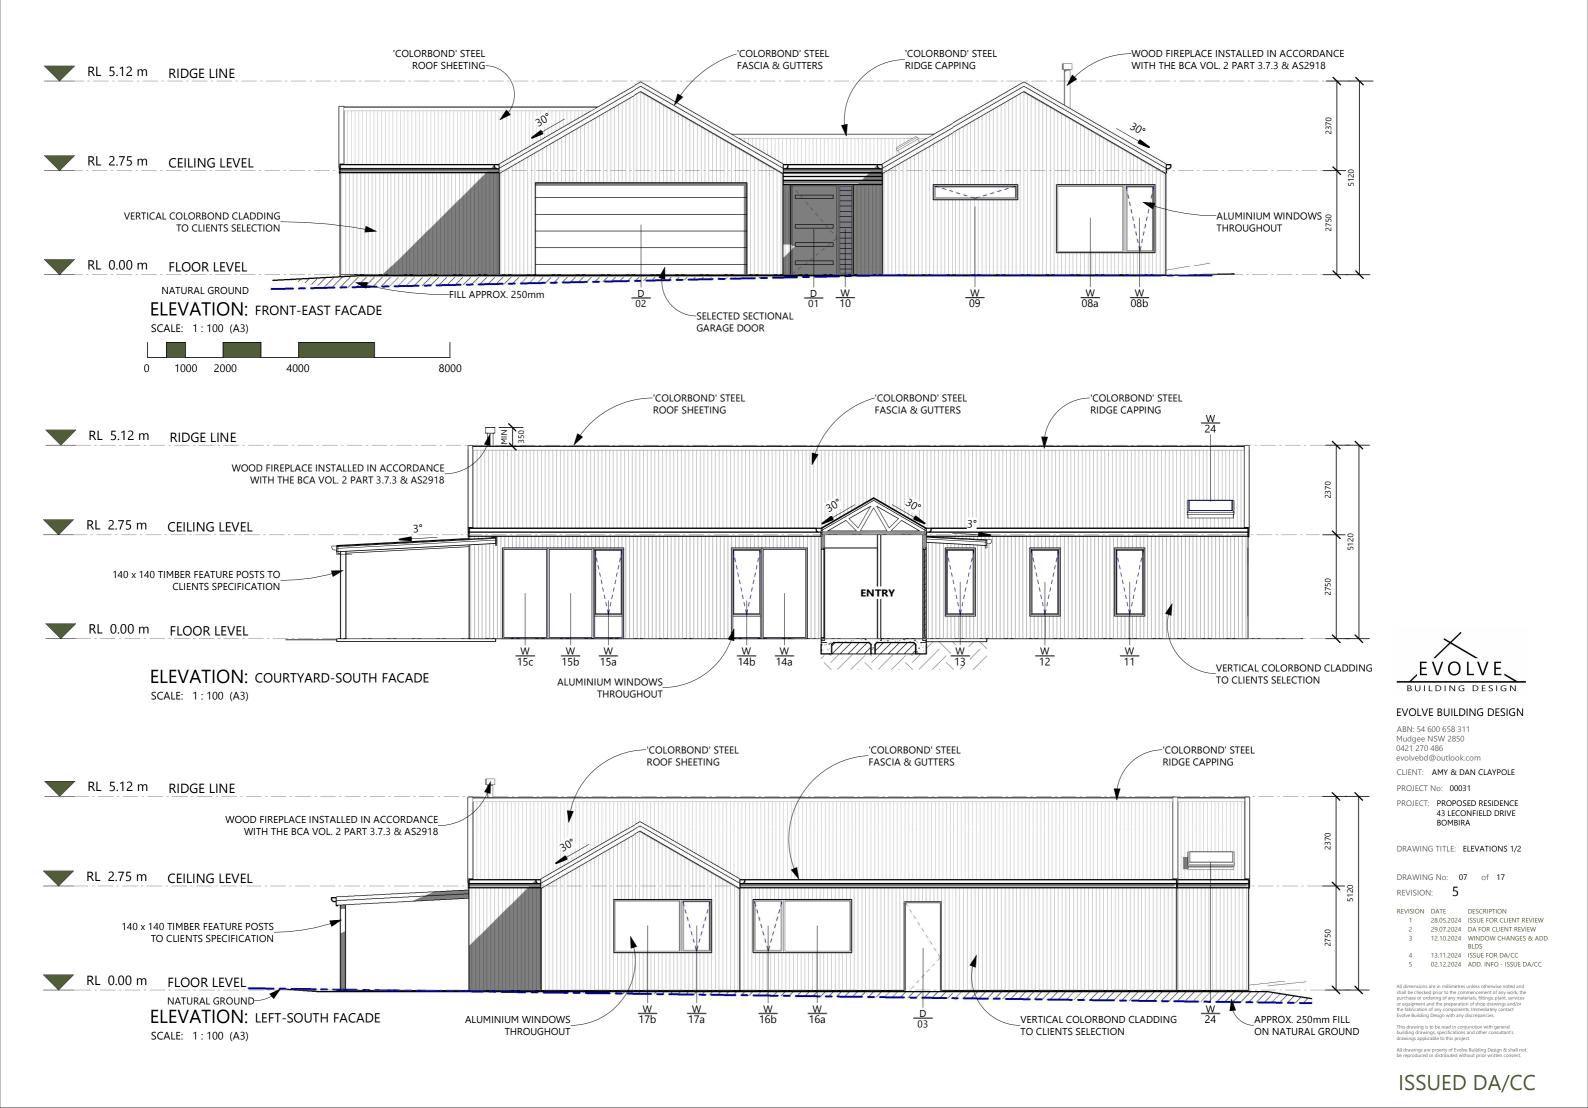BOMBIRA

DESCRIPTION

29.07.2024 DA FOR CLIENT REVIEW
12.10.2024 WINDOW CHANGES & ADD

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### **WINDOW & DOOR NOTES**

ALL GLASS IS TO BE SELECTED & INSTALLED IN ACCORDANCE BUT NOT EXCLUSIVELY WITH THE FOLLOWING AUSTRALIAN &/OR NEW ZEALAND

- AS 1288 GLASS IN BUILDINGS SELECTION &
- INSTALLATION
   AS 1170 MINIMUM WIND LOADS ON STRUCTURES
- AS/NZS 2208 SAFETY GLAZING MATERIALS IN BUILDINGS AS/NZS 4667 QUALITY REQUIREMENTS FOR CUT-TO-SIZE & PROCESSED GLASS

DIMENSIONS SHALL BE CONFIRMED ON SITE PRIOR TO

LINTELS OVER WINDOWS SHALL BE TO FRAME

WINDOW HEAD HEIGHTS TO BE 2400mm ABOVE THE FINISHED FLOOR LEVEL UNLESS NOTED OTHERWISE

UNLESS NOTED OTHERWISE ALL WINDOWS TO BE ALUMINIUM FRAMED WINDOWS WITH A SELECT POWDERCOAT FINISH & ALUMINIUM FRAMED STEEL MESH INSECT SCREENS COMPLYING WITH THE REQUIREMENTS OF

ALL GLAZING THAT IS 0.75M OR LESS ABOVE THE FFL MUST BE GLAZED WITH SAFETY GLASS IN ACCORDANCE WITH

EXTERNAL WINDOWS & DOORS TO BE SEALED USING RUBBER COMPRESSIVE STRIPS WHICH WILL RESTRICT AIR

WHERE THERE IN NO TRANSOM, COLONIAL BARS OR CHAIR RAIL, ALL FRAMELESS OR FULLY GLAZED DOORS & SIDELIGHTS CAPABLE OF BEING MISTAKEN FOR A DOORWAY OR OPENING, SHALL BE CLEARLY MARKED WITH A PERMANENT MOTIF OR OTHER DECORATIVE TREATMENT TO INDICATE ITS PRESENCE

UNLESS NOTED OTHERWISE ALL EXTERNAL DOORS TO BE TIMBER SOLID CORE & ALL INTERNAL DOORS ARE TO BE

EXTERNAL DOORS ARE TO BE FITTED WITH ALUMINIUM FRAMED MESH INSECT SCREENS

DOOR HANDLE & RELATED HARDWARE SHALL BE OF THE TYPE THAT ALLOWS THE DOOR TO BE UNLOCKED & OPENED

## **WINDOW SCHEDULE**

ID	HEIGHT		AREA	ORIENTATION		DESCRIPTION	GLAZING	SHADING	OVERSHADOWING
01a	1870	800	1.50 m <sup>2</sup>	NORTH	LW1908/1	ALUMINIUM FRAMED - ONE LOUVRE SECTION	ALUMINIUM, SINGLE, CLEAR	E 150 - 350 A/H	>4m H, 5-8m A
01b	1870	1870	3.50 m <sup>2</sup>	NORTH	F1919	ALUMINIUM FRAMED - ONE FIXED SECTION	ALUMINIUM, SINGLE, CLEAR	E 150 - 350 A/H	>4m H, 5-8m A
02a	1870	800	1.50 m <sup>2</sup>	NORTH	LW1908/1	ALUMINIUM FRAMED - ONE LOUVRE SECTION	ALUMINIUM, SINGLE, CLEAR	E 450 - 50 A/H	>4m H, 8-12m A
02b	1870	1870	3.50 m <sup>2</sup>	NORTH	F1919	ALUMINIUM FRAMED - ONE FIXED SECTION	ALUMINIUM, SINGLE, CLEAR	E 450 - 50 A/H	>4m H, 8-12m A
03a	1430	800	1.14 m <sup>2</sup>	NORTH	D1508	ALUMINIUM FRAMED - ONE DOUBLE-HUNG SECTION	ALUMINIUM, SINGLE, CLEAR	E 450 - 50 A/H	>4m H, 8-12m A
03b	1430	1800	2.57 m <sup>2</sup>	NORTH	F1518	ALUMINIUM FRAMED - ONE FIXED SECTION	ALUMINIUM, SINGLE, CLEAR	E 450 - 50 A/H	>4m H, 8-12m A
04a	1800	1800	3.24 m <sup>2</sup>	NORTH	F1818	ALUMINIUM FRAMED - ONE FIXED SECTION	ALUMINIUM, SINGLE, CLEAR	E 450 - 50 A/H	>4m H, 8-12m A
04b	1800	800	1.44 m <sup>2</sup>	NORTH	A1808	ALUMINIUM FRAMED - ONE AWNING SECTION	ALUMINIUM, SINGLE, CLEAR	E 450 - 50 A/H	>4m H, 8-12m A
05	600	800	0.48 m <sup>2</sup>	NORTH	A0608	ALUMINIUM FRAMED - ONE AWNING SECTION	ALUMINIUM, SINGLE, CLEAR	E 150 - 350 A/H	2-4m H, 2-5m A
06a	1200	600	0.72 m <sup>2</sup>	NORTH	A1206	ALUMINIUM FRAMED - ONE AWNING SECTION	ALUMINIUM, SINGLE, CLEAR	E 150 - 350 A/H	2-4m H, 2-5m A
06b	1200	1200	1.44 m <sup>2</sup>	NORTH	F1212	ALUMINIUM FRAMED - ONE FIXED SECTION	ALUMINIUM, SINGLE, CLEAR	E 150 - 350 A/H	2-4m H, 2-5m A
07	400	1800	0.72 m <sup>2</sup>	NORTH	F0418	ALUMINIUM FRAMED - ONE FIXED SECTION	ALUMINIUM, SINGLE, CLEAR	E 150 - 350 A/H	2-4m H, 2-5m A
08a	1800	1800	3.24 m <sup>2</sup>	EAST	F1818	ALUMINIUM FRAMED - ONE FIXED SECTION	ALUMINIUM, SINGLE, CLEAR	E 150, 1600 A/H	N/A
08b	1800	800	1.44 m <sup>2</sup>	EAST	A1808	ALUMINIUM FRAMED - ONE AWNING SECTION	ALUMINIUM, SINGLE, CLEAR	E 150, 1600 A/H	N/A
09	400	2250	0.90 m <sup>2</sup>	EAST	A0422	ALUMINIUM FRAMED - ONE AWNING SECTION	ALUMINIUM, SINGLE, CLEAR	E 150, 1200 A/H	N/A
10	2400	400	0.96 m <sup>2</sup>	EAST	LW2404/1	ALUMINIUM FRAMED - ONE LOUVRE SECTION	ALUMINIUM, SINGLE, CLEAR	V 1600, 2400 A/B	N/A
11	1800	800	1.44 m <sup>2</sup>	SOUTH	A1808	ALUMINIUM FRAMED - ONE AWNING SECTION	ALUMINIUM, SINGLE, CLEAR	E 150 - 350 A/H	N/A
12	1800	800	1.44 m <sup>2</sup>	SOUTH	A1808	ALUMINIUM FRAMED - ONE AWNING SECTION	ALUMINIUM, SINGLE, CLEAR	E 150 - 350 A/H	N/A
13	1800	800	1.44 m <sup>2</sup>	SOUTH	A1808	ALUMINIUM FRAMED - ONE AWNING SECTION	ALUMINIUM, SINGLE, CLEAR	E 150 - 350 A/H	N/A
14a	2400	1200	2.88 m <sup>2</sup>	SOUTH	F2412	ALUMINIUM FRAMED - ONE FIXED SECTION	ALUMINIUM, SINGLE, CLEAR	E 150 - 350 A/H	N/A
14b	2400	800	1.92 m <sup>2</sup>	SOUTH	A/F2408	ALUMINIUM FRAMED - ONE AWNING SECTION, ONE FIXED SECTION BELOW	ALUMINIUM, SINGLE, CLEAR	E 150 - 350 A/H	N/A
15a	2400	800	1.92 m <sup>2</sup>	SOUTH	A/F2408	ALUMINIUM FRAMED - ONE AWNING SECTION, ONE FIXED SECTION BELOW	ALUMINIUM, SINGLE, CLEAR	E 150 - 350 A/H	N/A
15b	2400	1200	2.88 m <sup>2</sup>	SOUTH	F2412	ALUMINIUM FRAMED - ONE FIXED SECTION	ALUMINIUM, SINGLE, CLEAR	E 150 - 350 A/H	N/A
15c	2400	1200	2.88 m <sup>2</sup>	SOUTH	F2412	ALUMINIUM FRAMED - ONE FIXED SECTION	ALUMINIUM, SINGLE, CLEAR	E 150 - 350 A/H	N/A
16a	1400	1800	2.52 m <sup>2</sup>	SOUTH	F1418	ALUMINIUM FRAMED - ONE FIXED SECTION	ALUMINIUM, SINGLE, CLEAR	E 150 - 350 A/H	N/A
16b	1400	800	1.12 m <sup>2</sup>	SOUTH	A1408	ALUMINIUM FRAMED - ONE AWNING SECTION	ALUMINIUM, SINGLE, CLEAR	E 150 - 350 A/H	N/A
17a	1400	800	1.12 m <sup>2</sup>	SOUTH	A1408	ALUMINIUM FRAMED - ONE AWNING SECTION	ALUMINIUM, SINGLE, CLEAR	E 100 - 1400 A/H	N/A
17b	1400	1800	2.52 m <sup>2</sup>	SOUTH	F1418	ALUMINIUM FRAMED - ONE FIXED SECTION	ALUMINIUM, SINGLE, CLEAR	E 100 - 1400 A/H	N/A
18a	1400	800	1.12 m <sup>2</sup>	WEST	A1408	ALUMINIUM FRAMED - ONE AWNING SECTION	ALUMINIUM, SINGLE, CLEAR	E 150 - 350 A/H	>4m H, 8-12m A
18b	1400	1800	2.52 m <sup>2</sup>	WEST	F1418	ALUMINIUM FRAMED - ONE FIXED SECTION	ALUMINIUM, SINGLE, CLEAR	E 150 - 350 A/H	>4m H, 8-12m A
19a	1400	800	1.12 m <sup>2</sup>	WEST	A1408	ALUMINIUM FRAMED - ONE AWNING SECTION	ALUMINIUM, SINGLE, CLEAR	E 150 - 350 A/H	N/A
19b	1400	1800	2.52 m <sup>2</sup>	WEST	F1418	ALUMINIUM FRAMED - ONE FIXED SECTION	ALUMINIUM, SINGLE, CLEAR	E 150 - 350 A/H	N/A
20a	1400	800	1.12 m <sup>2</sup>	WEST	A1408	ALUMINIUM FRAMED - ONE AWNING SECTION	ALUMINIUM, SINGLE, CLEAR	E 150 - 350 A/H	N/A
20b	1400	1800	2.52 m <sup>2</sup>	WEST	F1418	ALUMINIUM FRAMED - ONE FIXED SECTION	ALUMINIUM, SINGLE, CLEAR	E 150 - 350 A/H	N/A
21	2400	1800	4.32 m <sup>2</sup>	WEST	F2418	ALUMINIUM FRAMED - ONE FIXED SECTION	ALUMINIUM, SINGLE, CLEAR	E 150 - 350 A/H	1-2m H, <1.5m A
22	2400	2400	5.76 m <sup>2</sup>	WEST	FX2424	ALUMINIUM FRAMED - ONE SLIDING DOOR SECTION, ONE FIXED SECTION	ALUMINIUM, SINGLE, CLEAR	V 3800 - 2200 A/B	N/A
23	1870	1870	3.50 m <sup>2</sup>	WEST	F1919	ALUMINIUM FRAMED - ONE FIXED SECTION	ALUMINIUM, SINGLE, CLEAR	E 150 - 350 A/H	>4m H, 5-8m A
24	600	1200	0.72 m <sup>2</sup>	SOUTH	SL0612	ALUMINIUM FRAMED SKYLIGHT	ALUMINIUM, SINGLE, CLEAR	EXTERNAL ADJUSTABLE AWNING OR BLIND	N/A
30	700	1200	0.84 m <sup>2</sup>	EAST	SF0712	ALUMINIUM FRAMED - ONE FIXED SECTION, ONE SLIDING SECTION	ALUMINIUM, SINGLE, CLEAR	E 120 - 1240 A/H	2-4m H, 2-5m A
31	700	1200	0.84 m <sup>2</sup>	EAST	SF0712	ALUMINIUM FRAMED - ONE FIXED SECTION, ONE SLIDING SECTION	ALUMINIUM, SINGLE, CLEAR	E 120 - 1240 A/H	2-4m H, 2-5m A
32	400	1600	0.64 m <sup>2</sup>	SOUTH	SF0416	ALUMINIUM FRAMED - ONE FIXED SECTION, ONE SLIDING SECTION	ALUMINIUM, SINGLE, CLEAR	E 170 - 640 A/H	N/A
33	600	1800	1.08 m <sup>2</sup>	WEST	SF0618	ALUMINIUM FRAMED - ONE FIXED SECTION, ONE SLIDING SECTION	ALUMINIUM, SINGLE, CLEAR	E 120 - 1240 A/H	N/A

## **DOOR SCHEDULE**

ID	HEIGH1	WIDTH	ORIENTATION	DESCRIPTION	GLAZING	SHADING	OVERSHADOWING
01	2340	1200	EAST	TIMBER DOOR FRAME - 1 / EXTERNAL SOLID CORE HINGED ENTRY DOOR WITH PART GLAZED SECTION AND SELECT FINISH	TIMBER, SINLGE, CLEAR	V 1600 - 2400 A/B	N/A
02	2600	5600		1 / DOUBLE SECTIONAL GARAGE DOOR			
03	2400	920		TIMBER DOOR FRAME - 1 / SOLID CORE HINGED DOOR WITH SELECT FINISH			
04	2340	820	NORTH	TIMBER DOOR FRAME - 1 / EXTERNAL SOLID CORE HINGED DOOR WITH GLAZED SECTION & SELECT FINISH	ALUMINIUM, SINGLE, CLEAR	E 150 - 350 A/H	>4m H, 8-12m A
05	2340	920	NORTH	TIMBER DOOR FRAME - 1 / EXTERNAL SOLID CORE HINGED DOOR WITH GLAZED SECTION & SELECT FINISH	ALUMINIUM, SINGLE, CLEAR	E 150 - 350 A/H	2-4m H, 2-5m A
06	2400	920		TIMBER DOOR FRAME - 1 / INTERNAL HOLLOW CORE HINGED DOOR WITH SELECT PAINT FINISH			
07	2400	920		TIMBER DOOR FRAME - 1 / SOLID CORE HINGED DOOR WITH SELECT FINISH			
80	2400	920		TIMBER DOOR FRAME - 1 / INTERNAL HOLLOW CORE HINGED DOOR WITH SELECT PAINT FINISH			
09	2400	920		TIMBER DOOR FRAME - 1 / SOLID CORE HINGED DOOR WITH SELECT FINISH			
10	2400	920		TIMBER DOOR FRAME - 1 / INTERNAL HOLLOW CORE HINGED DOOR WITH SELECT PAINT FINISH			
11	2400	920		TIMBER DOOR FRAME - 1 / INTERNAL HOLLOW CORE HINGED DOOR WITH SELECT PAINT FINISH			
12	2040	620		TIMBER DOOR FRAME - 2 / INTERNAL HOLLOW CORE HINGED DOORS WITH SELECT PAINT FINISH			
13	2400	920		TIMBER DOOR FRAME - 1 / INTERNAL HOLLOW CORE HINGED DOOR WITH SELECT PAINT FINISH			
14	2400	920		TIMBER DOOR FRAME - 1 / INTERNAL HOLLOW CORE HINGED DOOR WITH SELECT PAINT FINISH			
15	2400	920		TIMBER DOOR FRAME - 1 / INTERNAL HOLLOW CORE HINGED DOOR WITH SELECT PAINT FINISH			
16	2040	720		TIMBER DOOR FRAME - 3 / INTERNAL HOLLOW CORE SLIDIING DOORS WITH SELECT PAINT FINISH			
19	2040	820		TIMBER DOOR FRAME - 1 / INTERNAL HOLLOW CORE HINGED DOOR WITH SELECT PAINT FINISH			
20	2040	820		TIMBER DOOR FRAME - 1 / INTERNAL HOLLOW CORE CAVITY SLIDING DOOR WITH SELECT PAINT FINISH			
21	2040	820		TIMBER DOOR FRAME - 1 / INTERNAL HOLLOW CORE CAVITY SLIDING DOOR WITH SELECT PAINT FINISH			
22	2040	820		TIMBER DOOR FRAME - 2 / INTERNAL HOLLOW CORE HINGED DOORS WITH SELECT PAINT FINISH			
23	2040	820		TIMBER DOOR FRAME - 2 / INTERNAL HOLLOW CORE HINGED DOORS WITH SELECT PAINT FINISH			
26	2040	820		TIMBER DOOR FRAME - 2 / INTERNAL HOLLOW CORE HINGED DOORS WITH SELECT PAINT FINISH			
27	2040	820		TIMBER DOOR FRAME - 2 / INTERNAL HOLLOW CORE HINGED DOORS WITH SELECT PAINT FINISH			
28	2040	820		TIMBER DOOR FRAME - 1 / INTERNAL HOLLOW CORE CAVITY SLIDING DOOR WITH SELECT PAINT FINISH			
30	2040	820	NORTH	ALUMINIUM DOOR FRAME - 2 / EXTERNAL HINGED DOOR WITH FULL GLAZED SECTION	ALUMINIUM, SINGLE, CLEAR	V 310 - 2400 A/B	N/A
31	2040	820	NORTH	ALUMINIUM DOOR FRAME - 2 / EXTERNAL HINGED DOOR WITH FULL GLAZED SECTION	ALUMINIUM, SINGLE, CLEAR	V 310 - 2400 A/B	N/A



## **EVOLVE BUILDING DESIGN**

ABN: 54 600 658 311 Mudgee NSW 2850 0421 270 486 evolvebd@outlook.com

CLIENT: AMY & DAN CLAYPOLE

PROJECT No: 00031

PROJECT: PROPOSED RESIDENCE 43 LECONFIELD DRIVE BOMBIRA


DRAWING TITLE: DOOR + WINDOW SCHEDULES

DRAWING No: 09 of 17

REVISION: 5 REVISION DATE DESCRIPTION 09.08.2023 CONCEPT DRAWINGS 28.05.2024 ISSUE FOR CLIENT REVIEW

29.07.2024 DA FOR CLIENT REVIEW
12.10.2024 WINDOW CHANGES & ADD
BLDS

4 13.11.2024 ISSUE FOR DA/CC 5 02.12.2024 ADD. INFO - ISSUE DA/CC

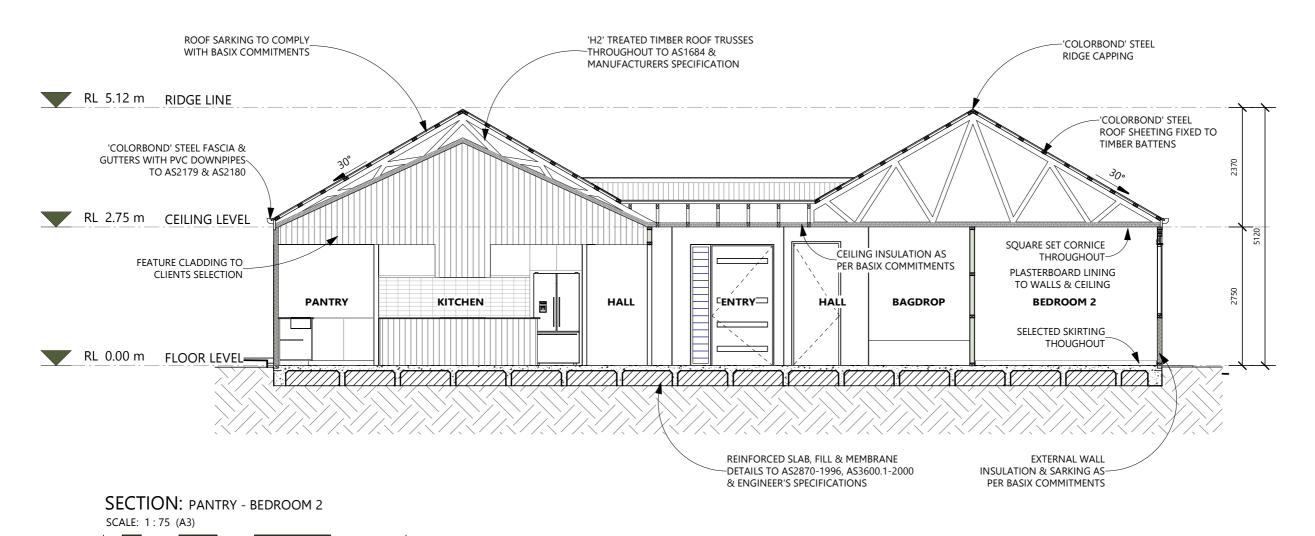

## **BASIX CERTIFICATE COMMITMENTS**

SET OUT BELOW REGULATE HOW THE PROPOSED DEVELOPMENT IS TO BE CARRIED OUT. T IS A CONDITION OF ANY DEVELOPMENT CONSENT GRANTED, OR COMPLYING DEVELOPEMNT CERTIFICATE ISSUES, FOR THE PROPOSED DEVELOPMENT, THAT BASIX COMMITMENTS BE COMPLIED WITH.

6000

## WATER

750

1500

SHOWERHEADS MIN. RATING OF 4 STAR (>4.5≤6L/min) **FIXTURES** 

3000

TOILET FLUSHING SYSTEMS MIN. RATING OF 6 STAR KITCHEN TAPS MIN. RATING OF 6 STAR

BATHROOM TAPS MIN. RATING OF 6 STAR

RAINWATER TANK AT LEAST 45,000 LITRES TO REGULATORY REQUIREMENTS WATER TANK

TO COLLECT RUNOFF AT LEAST 350m² ROOF AREA RAINWATER TANK MUST BE CONNECTED TO

- ALL TOILETS IN THE DEVELOPMENT

- EACH CLOTHES WASHER

- AT LEAST ONE OUTDOOR TAP
- A TAP THAT IS LOCATED WITHIN 10 METRES OF THE SWIMMING POOL

SWIMMING POOL THE SWIMMING POOL MUST NOT HAVE A VOLUME GREATER THAN 55KL

AND MUST HAVE A POOL COVER INSTALLED

## THERMAL

CONSTRUCTION	ADD. INSULATION REQ'D. (R-VALUE)	OTHER SPECIFICATIONS
FLOOR - CONCRETE SLAB ON GROUND	NIL	
EXTERNAL WALL - FRAMED (METAL CLAD)	3.50 (OR 4.00 INCLUDING CONSTRUCTION)	DARK (SOLAR ABSORBANCE 0.71-0.85)
INTERNAL WALL SHARED WITH GARAGE - PLASTERBOARD	1.08 (OR 1.50 INCLUDING CONSTRUCTION)	
INTERNAL WALL - PLASTERBOARD	NIL	
CEILING & ROOF - FLAT CEILING/PITCHED - METAL ROOF	CEILING - 6.4 (UP); ROOF - FOIL/SARKING	UNVENTILATED; DARK (SOLAR ABSORBANCE >0.79)
CEILING & ROOF - RAKED CEILING/PITCHED OR SKILLION - METAL ROOF	CEILING - 5 (UP); ROOF - FOIL/SARKING	UNVENTILATED; DARK (SOLAR ABSORBANCE >0.79)

ALL PROPOSED WINDOWS, GLAZED DOORS AND SHADING DEVICES LISTED IN WINDOW SCHEDULE ABOVE MUST BE INSTALLED

### **ENERGY**

GAS INSTANTANEOUS SYSTEM ≥6.5 STARS HOT WATER

≥1 LIVING AREA: AIR CONDITIONING DUCTING ONLY COOLING ≥1 BEDROOMS: AIR CONDITIONING DUCTING ONLY

>1 LIVING AREA: WOOD HEATER

HEATING ≥1 BEDROOMS: AIR CONDITIONING DUCTING ONLY

≥1 BATHROOM: INDIVIDUAL FAN, DUCTED TO FACADE OR ROOF; MANUAL SWITCH ON/OFF VENTILATION

KITCHEN: NO MECHANICAL VENTILATION; MANUAL SWITCH ON/OFF

LAUNDRY: NATURAL VENTILATION ONLY

THE APPLICATION MUST ENSURE THAT A MINIMUM OF 80% OF LIGHT FIXTURES ARE FITTED WITH ARTIFICIAL LIGHTING FLUORESCENT, COMPACT FLUORESCENT, OR LED LAMPS

A WINDOW AND/OR SKYLIGHT MUST BE INSTALLED IN THE KITCHEN

NATURAL LIGHTING A WINDOW AND/OR SKYLIGHT MUST BE INSTALLED IN AT LEAST 2 BATHROOMS/TOILETS

A SOLAR (GAS BOOSTED) HEATING SYSTEM MUST BE INSTALLED SINGLE SPEED PUMP  $\geq 6$  STARS WITH TIMER MUST BE INSTALLED SWIMMING POOL

ALTERNATIVE ENERGY A PHOTOCOLATIC SYSTEM WITH CAPACITY TO GENERATE AT LEASE 2 PEAK KILOWATTS OF ELECTRICITY, INSTALLED AT

An angle between 25° & 35° to the Horizontal facing North

INDUCTION COOKTOP & ELECTRIC OVEN MUST BE INSTALLED OTHER A FIXED OUTDOOR CLOTHES DRYING LINE MUST BE INSTALLED



## **EVOLVE BUILDING DESIGN**

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CLIENT: AMY & DAN CLAYPOLE

PROJECT No: 00031

evolvebd@outlook.com

PROJECT: PROPOSED RESIDENCE 43 LECONFIELD DRIVE **BOMBIRA** 


DRAWING TITLE: SECTION & BASIX SCHEDULE

DRAWING No: 10 of 17 REVISION: 5

REVISION DATE DESCRIPTION

09.08.2023 CONCEPT DRAWINGS 29.07.2024 DA FOR CLIENT REVIEW 12.10.2024 WINDOW CHANGES & ADD BLDS 13.11.2024 ISSUE FOR DA/CC

02.12.2024 ADD. INFO - ISSUE DA/CC

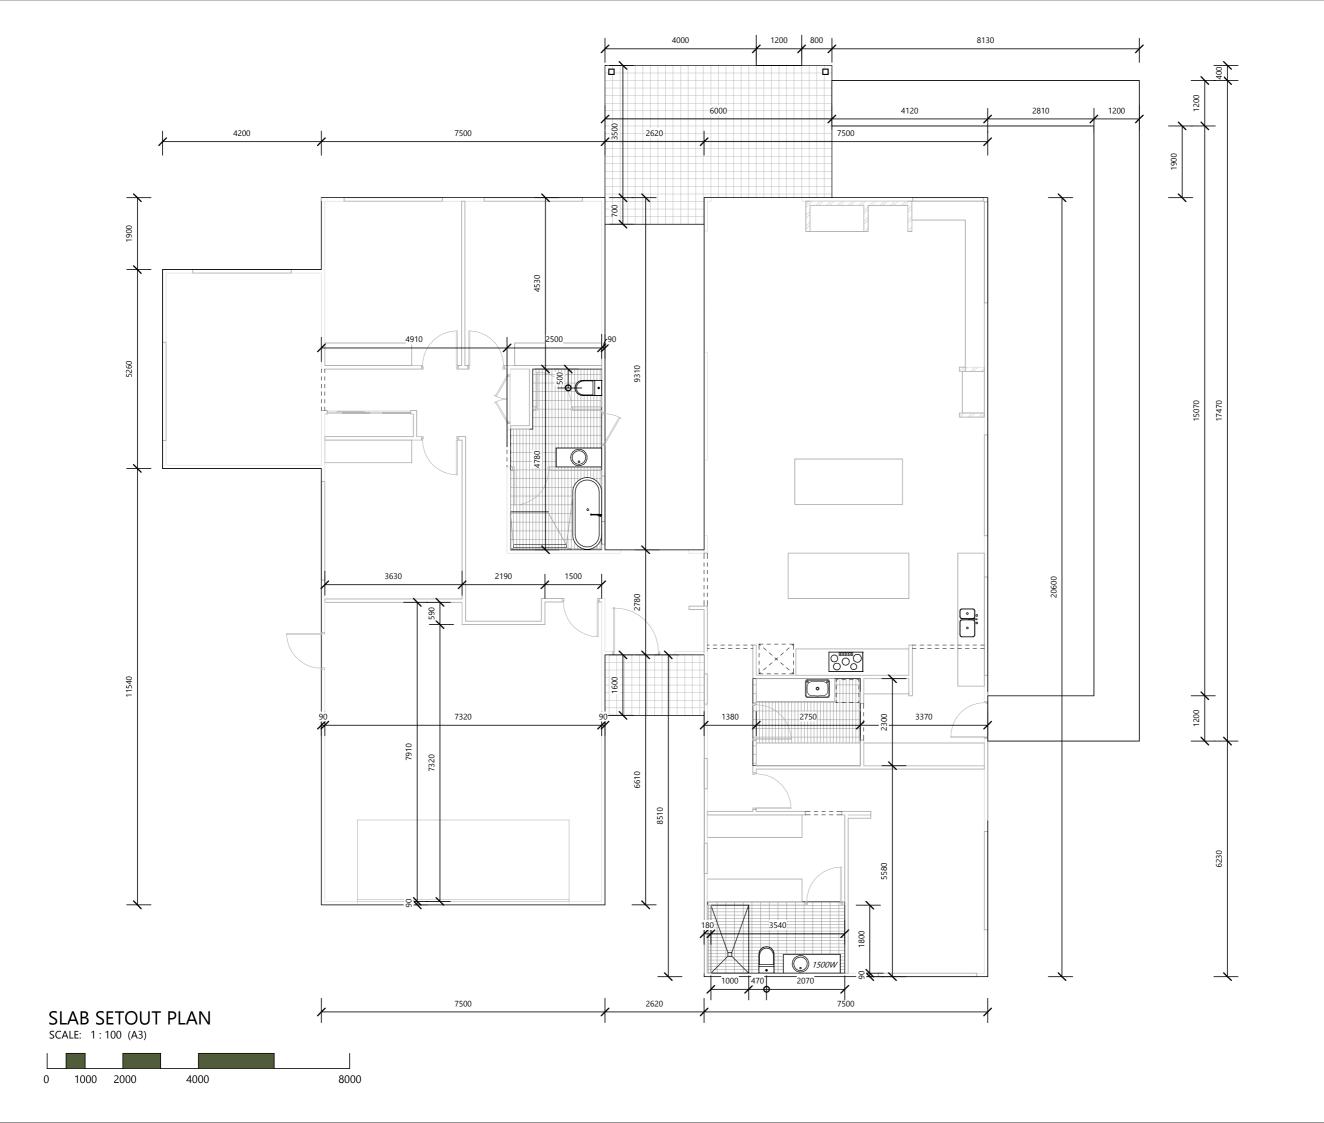



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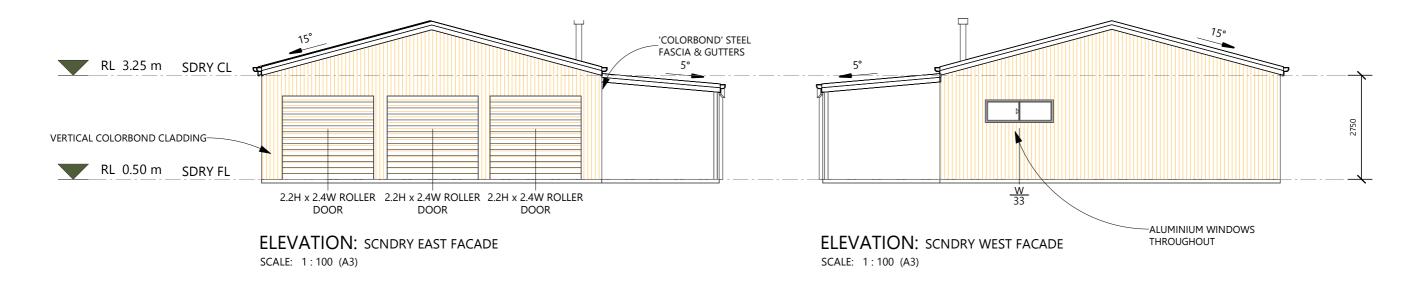
PROJECT No: 00031


PROJECT: PROPOSED RESIDENCE 43 LECONFIELD DRIVE BOMBIRA


DRAWING TITLE: HOUSE SLAB SETOUT

DRAWING No: 11 of 17

revision: 5



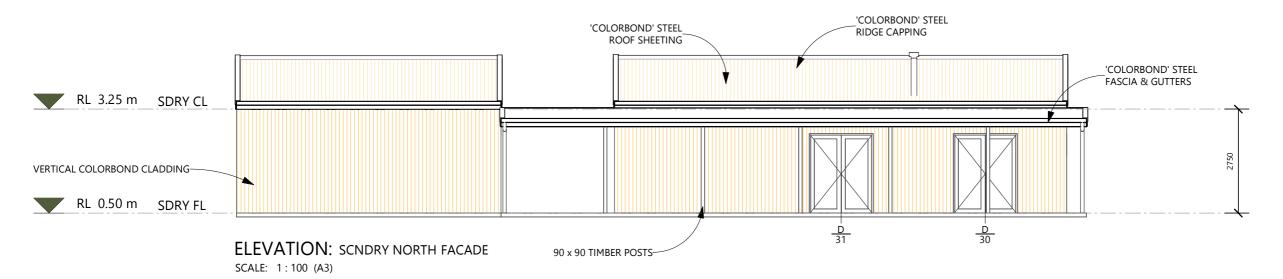

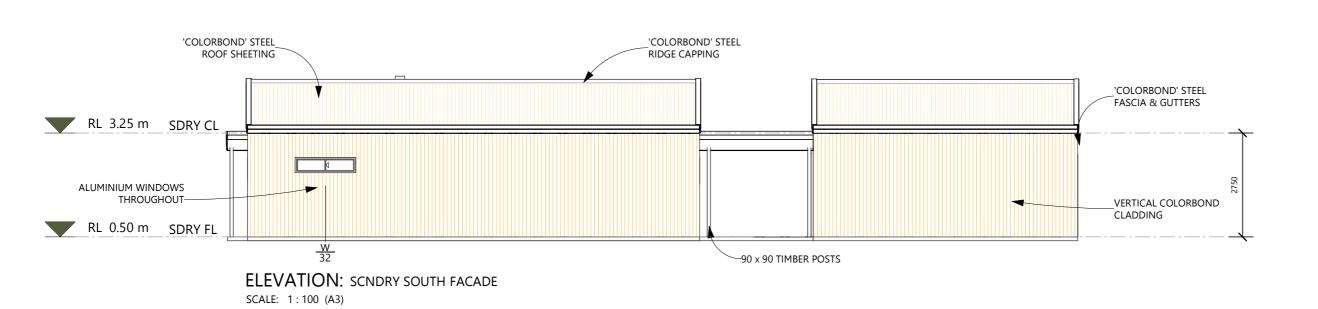



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CLIENT: AMY & DAN CLAYPOLE

PROJECT No: 00031

PROJECT: PROPOSED RESIDENCE 43 LECONFIELD DRIVE BOMBIRA

DRAWING TITLE: SCNDRY DWELLING ELEVATIONS

DRAWING No: 13 of 17

REVISION: 5

REVISION:

 REVISION
 DATE
 DESCRIPTION


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All dimensions are in millimetres unless otherwise noted ar shall be checked prior to the commencement of any work, purchase or ordering of any materials, fittings, plant, servic or equipment and the preparation of shop drawings and/ou the fabrication of any components. Immediately contact


building drawings, specifications and other consult drawings applicable to this project.


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## PART SITE LAYOUT - STAGE 2


SCALE: 1:200 (A3)



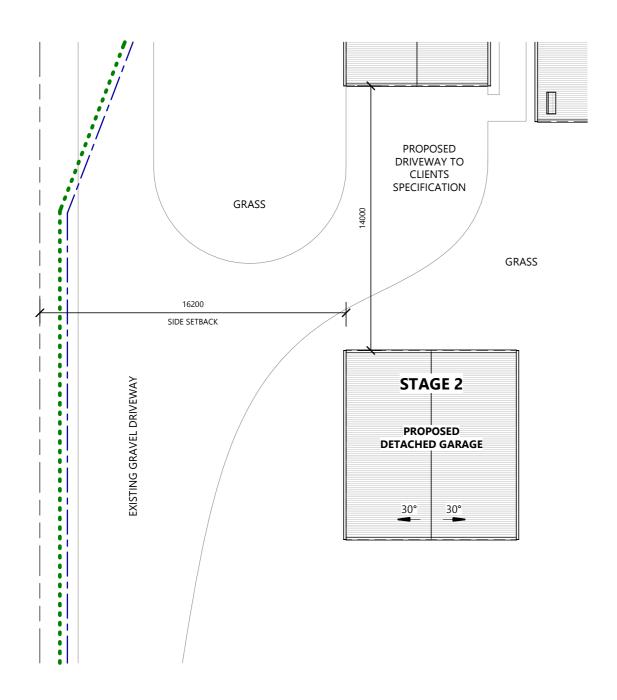
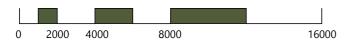
# DETACHED GARAGE FLOOR LAYOUT

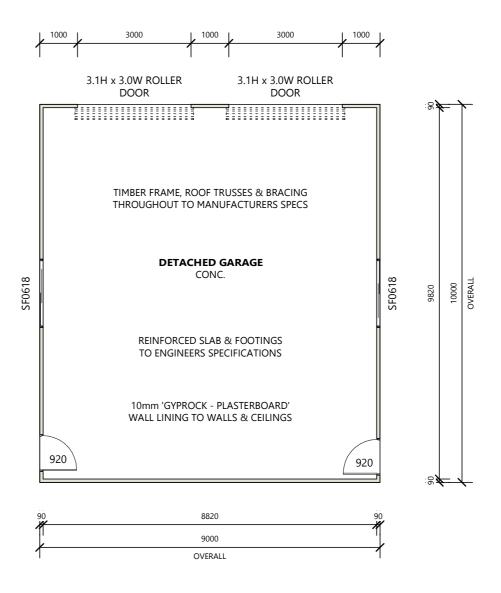SCALE: 1:100 (A3)

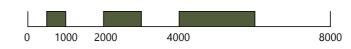



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PROJECT No: 00031

PROJECT: PROPOSED RESIDENCE 43 LECONFIELD DRIVE BOMBIRA

DRAWING TITLE: DETACHED GARAGE SITE & FLOOR


PLANS - STAGE 2
DRAWING No: 14 of 17


revision: 5

 REVISION
 DATE
 DESCRIPTION

 4
 13.11.2024
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PROJECT No: 00031

PROJECT: PROPOSED RESIDENCE 43 LECONFIELD DRIVE BOMBIRA

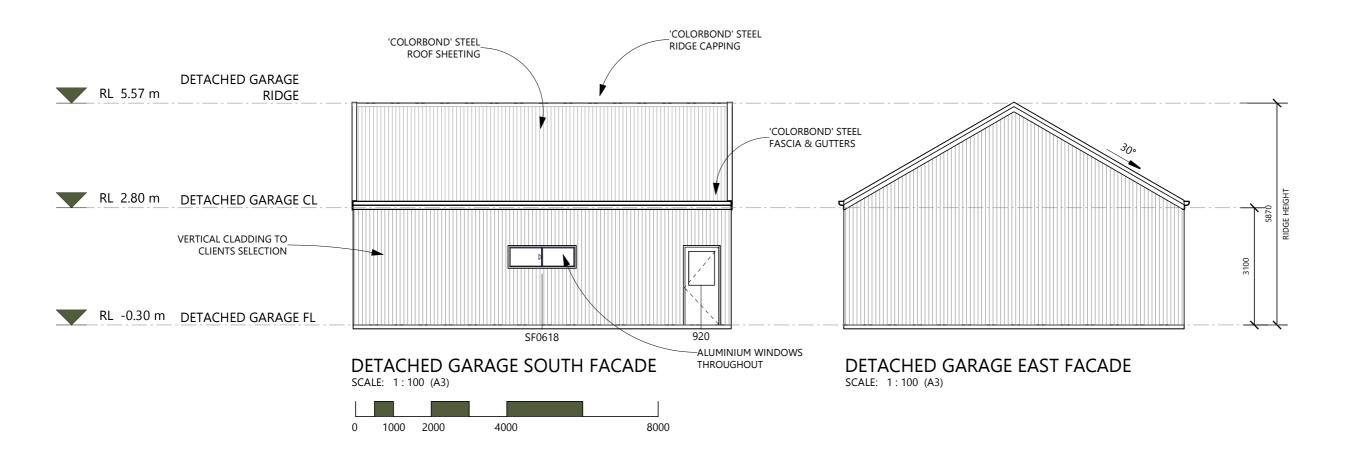DRAWING TITLE: DETACHED GARAGE ELEVATIONS

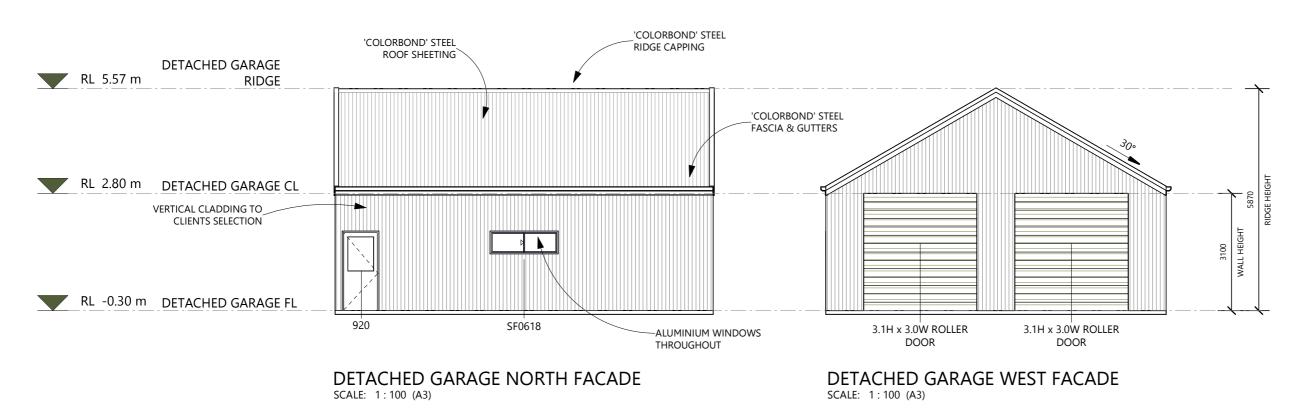DRAWING No: 15 of 17 REVISION: 5

 REVISION
 DATE
 DESCRIPTION


 4
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 02.12.2024
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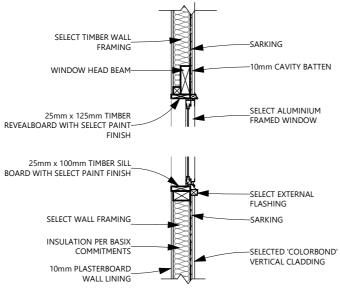
This drawing is to be read in conjunction with gene building drawings, specifications and other consult drawings applicable to this project.

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## **EAVE DETAIL**


SCALE: 1:20 (A3)



## SQUARE SET WINDOW SECTION DETAIL SCALE: 1:20 (A3)

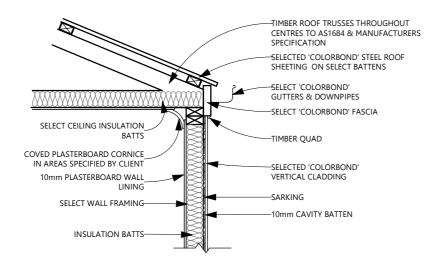
NOTES: FOR SLAB DETAILS REFER TO ENGINEERS DESIGN AND SPECIFICATION

THE FOUNDATION SHALL BE TREATED TO PROTECT AGAINST INFESTATION BY TERMITES IN ACCORDANCE WITH AS 3660.1-2000

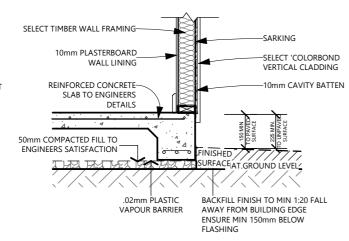


## SLAB EDGE DETAIL


SCALE: 1:20 (A3)

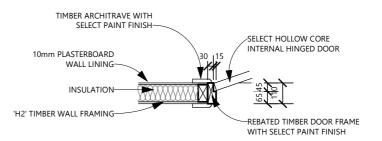

## INTERNAL DOOR DETAIL

SCALE: 1:20 (A3)

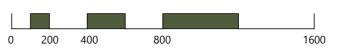

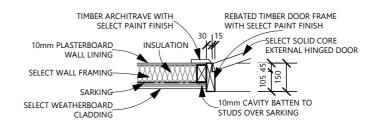

## EXTERNAL DOOR DETAIL SCALE: 1:20 (A3)

TIMBER ARCHITRAVE WITH SELECT PAINT FINISH 10mm PLASTERBOARD INSULATION 5mm x 100mm TIMBER WINDOW REVEAL WALL LINING BOARD WITH SELECT PAINT FINISH -SELECT ALUMINIUM FRAMED WINDOW SARKING EXTERNAL TIMBER ARCHITRAVE WITH SELECTED PAINT FINISH 10mm CAVITY BATTEN TO SELECT WALL STUDS OVER SARKING WEATHERBOARD CLADDING

## WINDOW PLAN DETAIL SCALE: 1:20 (A3)



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evolvebd@outlook.com CLIENT: AMY & DAN CLAYPOLE

PROJECT No: 00031

PROJECT: PROPOSED RESIDENCE 43 LECONFIELD DRIVE BOMBIRA

DRAWING TITLE: CONSTRUCTION DETAILS

DRAWING No: 16 of 17

REVISION: 5

REVISION DATE DESCRIPTION 09.08.2023 CONCEPT DRAWINGS 29.07.2024 DA FOR CLIENT REVIEW

12.10.2024 WINDOW CHANGES & ADD BLDS 13.11.2024 ISSUE FOR DA/CC

02.12.2024 ADD. INFO - ISSUE DA/CO

## **SAFE DESIGN OF STRUCTURES NOTES:**

FOR THE PURPOSE OF BUILDING, THE FOLLOWING SAFETY GUIDELINES ARE SET OUT HENCEFORTH IN ACCORDANCE WITH THE WORK HEALTH & SAFETY ACT 2011, WORK HEALTH & SAFETY REGULATION 2011 & THE SAFE DESIGN OF STRUCTURES CODE OF

THE GUIDELINES CONTAIN WORK HEALTH & SAFETY INFORMATION & MAY INCLUDE SOME OF YOUR OBLIGATIONS UNDER THE VARIOUS LEGISLATIONS THAT WORKCOVER NSW ADMINISTERS. TO ENSURE YOU COMPLY WITH YOUR LEGAL OBLIGATIONS YOU MUST REFER TO THE APPROPRIATE LEGISLATION.

#### **FALLS, SLIPS, TRIPS**

## **WORKING AT HEIGHTS**

## i. DURING CONSTRUCTION

WHEREVER POSSIBLE, COMPONENTS FOR THIS BUILDING SHOULD BE PREFABRICATED OFF-SITE OR AT GROUND LEVEL TO MINIMISE THE RISK OF WORKERS FALLING MORE THAN TWO METRES. HOWEVER, CONSTRUCTION OF THIS BUILDING WILL REQUIRE WORKERS TO BE WORKING AT HEIGHTS WHERE A FALL IN EXCESS OF TWO METRES IS POSSIBLE & INJURY IS LIKELY TO RESULT FROM SUCH A FALL. TEMPORARY WORK PLATFORMS ARE TO BE ERECTED & MAINTAINED BY THE PRINCIPAL CONTRACTOR AS REQUIRED THROUGHOUT CONSTRUCTION WHEREVER A PERSON IS REQUIRED TO WORK IN A SITUATION WHERE FALLING MORE THAN TWO METRES IS A POSSIBILITY. THE ERECTION OF ALL PLATFORMS, HOARDINGS, OLITRIGGERS & SCAFFOLDING SHALL BE CONSTRUCTED IN ACCORDANCE WITH THE REQUIREMENTS OF THE RELEVANT AUTHORITIES & THE APPLICABLE AUSTRALIAN STANDARDS.

#### ii. DURING OPERATION OR MAINTENANCE

FOR HOUSES OR OTHER LOW-RISE BUILDINGS WHERE SCAFFOLDING IS APPROPRIATE: CLEANING & MAINTENANCE OF WINDOWS, WALLS, ROOF OR OTHER COMPONENTS OF THIS BUILDING WILL REQUIRE PERSONS TO BE SITUATED WHERE A FALL FROM A HEIGHT IN EXCESS OF TWO METRES IS POSSIBLE. WHERE THIS TYPE OF ACTIVITY IS REQUIRED, A FALL ARREST SYSTEM, SCAFFOLDING, LADDERS OR TRESTLES SHOULD BE USED IN ACCORDANCE WITH RELEVANT CODES OF PRACTICE, REGULATIONS OR LEGISLATION.

WHERE AN ANCHORAGE & FALL ARREST SYSTEM IS TO BE INSTALLED, THE ANCHORAGE & FALL ARREST SYSTEM & ALL ASSOCIATED HARNESSES & ACCESSORIES MUST BE MAINTAINED THROUGHOUT THE LIFECYCLE OF THE BUILDING & INSPECTED ON A REGULAR BASIS AT LEAST ONCE IN EVERY 6 MONTHS.

#### SLIPPERY OR LINEVEN SLIREACES

## i. FLOOR FINISHES SPECIFIED

IE FINISHES HAVE REEN SPECIFIED BY DESIGNER THESE HAVE REEN SELECTED TO MINIMISE THE RISK OF FLOORS & PAVED AREAS BECOMING SLIPPERY WHEN WET OR WHEN WALKED ON WITH WET SHOES/FEET. ANY CHANGES TO THE SPECIFIED FINISH SHOULD BE MADE IN CONSULTATION WITH THE DESIGNER OR, IF THIS IS NOT PRACTICAL SURFACES WITH AN EQUIVALENT OR BETTER SLIP RESISTANCE SHOULD BE CHOSEN.

#### ii FLOOR FINISHES BY OWNER

IF DESIGNER HAS NOT BEEN INVOLVED IN THE SELECTION OF SURFACE FINISHES, THE OWNER IS RESPONSIBLE FOR THE SELECTION OF SURFACE FINISHES IN THE PEDESTRIAN TRAFFICABLE AREAS OF THIS BUILDING. SURFACES SHOULD BE SELECTED IN ACCORDANCE WITH AS HB 197:1999 AND AS/NZ 4586:2004.

#### iii STEPS LOOSE OBJECTS & LINEVEN SURFACES

DUE TO DESIGN RESTRICTIONS FOR THIS BUILDING, STEPS &/OR RAMPS ARE INCLUDED IN THE BUILDING WHICH MAY BE A HAZARD TO WORKERS CARRYING OBJECTS OR OTHERWISE OCCUPIED. STEPS SHOULD BE CLEARLY MARKED WITH BOTH VISUAL AND TACTILE WARNING DURING CONSTRUCTION, MAINTENANCE, DEMOLITION & AT ALL TIMES WHEN THE BUILDING OPERATES AS A WORKPLACE.

iv. Building owners & occupiers should monitor the pedestrian access ways & in particular access. TO AREAS WHERE MAINTENANCE IS ROUTINELY CARRIED OUT TO ENSURE THAT SURFACES HAVE NOT MOVED OR CRACKED SO THAT THEY RECOME LINEVEN & PRESENT A TRIP HAZARD SPILLS LOOSE MATERIAL STRAY ORIECTS OR ANY OTHER MATTER THAT MAY CAUSE A SLIP OR TRIP HAZARD SHOULD BE CLEANED OR REMOVED FROM ACCESS

v. Contractors should be required to maintain a tidy work site during construction, maintenance OR DEMOLITION TO REDUCE THE RISK OF TRIPS & FALLS IN THE WORKPLACE. MATERIALS FOR CONSTRUCTION OR MAINTENANCE SHOULD BE STORED IN DESIGNATED AREAS AWAY FROM ACCESS WAYS & WORK AREAS.

vi. ALTHOUGH DURING SPECIFICATION CARE HAS BEEN TAKEN TO ENSURE THE USE OF MATERIALS THAT ARE CHARACTERISTICALLY DEEMED AS 'NON-SLIP', THE DESIGNER IS UNABLE TO CONFIRM NOR CERTIFY THE SLIP RESISTANCE OF EXISTING MATERIALS LISED THROUGHOUT THE EXISTING RUILDING IT IS RECOMMENDED THAT SUP RESISTANCE TESTING BE UNDERTAKEN ON THE EXISTING MATERIALS IN ACCORDANCE WITH AUSTRALIAN STANDARDS TO ENSURE COMPLIANCE WITH BUILDING CODE OF AUSTRALIA.

vi. ALTHOUGH THE ROOF HAS BEEN DESIGNED IN ACCORDANCE WITH THE BUILDING CODE OF AUSTRALIA & ALL RELEVANT STANDARDS, THE CLIENT IS TO BE AWARE THAT THE ROOF MATERIALS HAS POTENTIAL FRAGILITY & SLIP RESISTANCE ISSUES THAT MAY ARISE THROUGHOUT CONSTRUCTION & THE LIFECYCLE OF THE BUILDING WHEN WORK IS UNDERTAKEN ON THE ROOF, ESPECIALLY DURING INCLEMENT WEATHER

## **FALLING OBJECTS**

## LOOSE MATERIALS OR SMALL OBJECTS

CONSTRUCTION, MAINTENANCE OR DEMOLITION WORK ON OR AROUND THIS BUILDING IS LIKELY TO INVOLVE PERSONS WORKING ABOVE GROUND LEVEL OR ABOVE FLOOR LEVELS. WHERE THIS OCCURS ONE OR MORE OF THE FOLLOWING MEASURES SHOULD BE TAKEN TO AVOID OBJECTS FALLING FROM THE AREA WHERE THE WORK IS BEING CARRIED OUT ONTO PERSONS BELOW.

- PREVENT OR RESTRICT ACCESS TO AREAS BELOW WHERE THE WORK IS BEING CARRIED OUT. PROVIDE TOEBOARDS TO SCAFFOLDING OR WORK PLATFORMS.
- PROVIDE PROTECTIVE STRUCTURE BELOW THE WORK AREA. ENSURE THAT ALL PERSONS BELOW THE WORK AREA HAVE PERSONAL PROTECTIVE EQUIPMENT (PPE).

DURING CONSTRUCTION, RENOVATION OR DEMOLITION OF THIS BUILDING, PARTS OF THE STRUCTURE INCLUDING FABRICATED STEELWORK, HEAVY PANELS & MANY OTHER COMPONENTS WILL REMAIN STANDING PRIOR TO OR AFTER SUPPORTING PARTS ARE IN PLACE. CONTRACTORS SHOULD ENSURE THAT TEMPORARY BRACING OR OTHER REQUIRED SUPPORT IS IN PLACE AT ALL TIMES WHEN COLLAPSE WHICH MAY INJURE PERSONS IN THE AREA IS A POSSIBILITY.

MECHANICAL LIFTING OF MATERIALS & COMPONENTS DURING CONSTRUCTION, MAINTENANCE OR DEMOLITION PRESENTS A RISK OF FAILING ORIECTS. CONTRACTORS SHOULD ENSURE THAT APPROPRIATE LIFTING DEVICES ARE USED, THAT LOADS ARE PROPERLY SECURED & THAT ACCESS TO AREAS BELOW THE LOAD IS PREVENTED OR

### FIRE & EMERGENCIES

IT IS THE RESPONSIBILITY OF THE CLIENT TO ENSURE ALL PERSONNEL & VISITING CLIENTELE ARE AWARE OF ALL FIRE SAFETY PROCEDURES, WITH EMERGENCY ROUTES & EXITS DISPLAYED THROUGHOUT THE BUILDING & MAINTAINED THROUGHOUT THE LIFECYCLE OF THE BUILDING. NO COMBUSTIBLE MATERIAL & RUBBISH WILL BE LEFT ON SITE AS TO CAUSE A FIRE HAZARD

### TRAFFIC MANAGEMENT

FOR BUILDING ON A MAJOR ROAD, NARROW ROAD OR STEEPLY SLOPING ROAD.

PARKING OF VEHICLES OR LOADING/UNLOADING OF VEHICLES ON THIS ROADWAY MAY CAUSE A TRAFFIC HAZARD, DURING CONSTRUCTION, NO COMBUSTIBLE MATERIAL & RUBBISH WILL BE LEFT ON SITE AS TO CAUSE A FIRE HAZARD. MANAGEMENT PERSONNEL SHOULD BE RESPONSIBLE FOR THE SUPERVISION OF THESE AREAS.

#### FOR BUILDING WHERE ON-SITE LOADING/UNLOADING IS RESTRICTED:

CONSTRUCTION OF THIS BUILDING WILL REQUIRE LOADING & UNLOADING OF MATERIALS ON THE ROADWAY. DELIVERIES SHOULD BE WELL PLANNED TO AVOID CONGESTION OF LOADING AREAS & TRAINED TRAFFIC MANAGEMENT PERSONNEL SHOULD BE USED TO SUPERVISE LOADING/UNLOADING AREAS.

#### FOR ALL BUILDINGS:

BUSY CONSTRUCTION & DEMOLITION SITES PRESENT A RISK OF COLLISION WHERE DELIVERIES & OTHER TRAFFIC ARE MOVING WITHIN THE SITE. A TRAFFIC MANAGEMENT PLAN SUPERVISED BY TRAINED TRAFFIC MANAGEMENT PERSONNEL SHOULD BE ADOPTED FOR THE WORK SITE.

### SERVICES

RUPTURE OF SERVICES DURING EXCAVATION OR OTHER ACTIVITY CREATES A VARIETY OF RISKS INCLUDING RELEASE OF HAZARDOUS MATERIAL. EXISTING SERVICES ARE LOCATED ON OR AROUND THIS SITE. WHERE KNOWN, THESE ARE IDENTIFIED ON THE PLANS BUT THE EXACT LOCATION & EXTENT OF SERVICES MAY VARY FROM THAT INDICATED. SERVICES SHOULD BE LOCATED USING AN APPROPRIATE SERVICE (SUCH AS DIAL BEFORE YOU DIG), APPROPRIATE EXCAVATION PRACTICE SHOULD BE USED &, WHERE NECESSARY, SPECIALIST CONTRACTORS SHOULD BE USED.

#### LOCATION WITH UNDERGROUND POWER:

UNDERGROUND POWER LINES MAY BE LOCATED IN OR AROUND THIS SITE, ALL UNDERGROUND POWER LINES MUST BE DISCONNECTED OR CAREFULLY LOCATED & ADEOUATE WARNING SIGNS USED PRIOR TO ANY CONSTRUCTION, MAINTENANCE OR DEMOLITION COMMENCING.

#### LOCATIONS WITH OVERHEAD POWERLINES:

OVERHEAD POWERLINES MAY BE NEAR OR ON THIS SITE. THESE POSE A RISK OF ELECTROCUTION IF STRUCK OR APPROACHED BY LIFTING DEVICES OR OTHER PLANT & PERSONS WORKING ABOVE GROUND LEVEL. WHERE THERE IS A DANGER OF THIS OCCURRING POWERLINES SHOULD BE WHERE PRACTICAL DISCONNECTED OR RELOCATED. WHERE THIS IS NOT PRACTICAL ADEQUATE WARNING IN THE FORM OF BRIGHT COLOURED TAPE OR SIGNAGE SHOULD BE USED OR A PROTECTIVE BARRIER PROVIDED.

### **EARTHWORKS**

IT IS THE RESPONSIBILITY OF THE PRINCIPAL CONTRACTOR TO ESTABLISH THE LOCATION & THE LEVEL OF ALL EXISTING SERVICES PRIOR TO THE COMMENCEMENT OF ANY WORK ANY DISCREPANCIES SHALL BE REPORTED. TO THE SUPERINTENDENT. CLEARANCES SHALL BE OBTAINED FROM THE RELEVANT SERVICE AUTHORITY

TO ENABLE THE PLACEMENT OF NEW STORMWATER SERVICES. TRENCH EXCAVATIONS WILL OCCUR ON SITE. IT IS TO BE THE RESPONSIBILITY OF THE PRINCIPAL CONTRACTOR TO ENSURE THAT ALL SAFETY RISKS ASSOCIATED WITH TRENCH EXCAVATION ARE IDENTIFIED. ADDRESSED & ADHERED TO THROUGHOUT CONSTRUCTION.

#### MANUAL TASKS

COMPONENTS WITHIN THIS DESIGN WITH A MASS IN EXCESS OF 25KG SHOULD BE LIFTED BY TWO OR MORE WORKERS OR BY MECHANICAL LIFTING DEVICE, WHERE THIS IS NOT PRACTICAL, SUPPLIERS OR FABRICATORS

ALL MATERIAL PACKAGING, BUILDING & MAINTENANCE COMPONENTS SHOULD CLEARLY SHOW THE TOTAL MASS OF PACKAGES & WHERE PRACTICAL ALL ITEMS SHOULD BE STORED ON SITE IN A WAY WHICH MINIMISES BENDING BEFORE LIFTING. ADVICE SHOULD BE PROVIDED ON SAFE LIFTING METHODS IN ALL AREAS WHERE LIFTING MAY OCCUR. CONSTRUCTION, MAINTENANCE & DEMOLITION OF THIS BUILDING WILL REQUIRE THE USE OF PORTABLE TOOLS & EQUIPMENT. THESE SHOULD BE SPECIFICATIONS & NOT USED WHERE FAULTY OR (IN THE CASE OF FLECTRICAL FOLIPMENT) NOT CARRYING A CURRENT FLECTRICAL SAFETY TAG. ALL SAFETY GUARDS OR DEVICES SHOULD BE REGULARLY CHECKED & PERSONAL PROTECTIVE EQUIPMENT SHOULD BE USED IN ACCORDANCE WITH MANUFACTURER'S SPECIFICATION.

## STRUCTURAL SAFETY

ALL PROTECTION WORKS TO ANY ADJOINING BUILDING (AS REQUIRED) WILL BE IN PLACE BEFORE DEMOLITION WORKS

DEMOLITION & REMOVAL OF THE BUILDING SHALL BE UNDERTAKEN IN A CAREFUL & PROPER MANNER & WITH A MINIMUM DISTURBANCE TO THE ADJOINING BUILDINGS & TO THE PUBLIC & THE OCCUPANTS.

ALL PRACTICABLE PRECAUTIONS SHALL BE TAKEN TO AVOID DANGER FROM COLLAPSE OF A BUILDING WHEN ANY PART OF A FRAMED MEMBER IS REMOVED.

NO NEW OR EXISTING WALL OR OTHER STRUCTURE SHALL BE LEFT FREE STANDING & UNATTENDED WITHOUT TEMPORARY BRACING OR SUPPORTS IN SUCH A CONDITION THAT IT MAY COLLAPSE DUE TO WIND OR VIBRATION

## **CONFINED SPACES**

### **FXCAVATION**

CONSTRUCTION OF THIS BUILDING & SOME MAINTENANCE ON THE BUILDING WILL REQUIRE EXCAVATION & INSTALLATION SHOULD BE CARRIED OUT USING METHODS WHICH DO NOT REQUIRE WORKERS TO ENTER THE EXCAVATION. WHERE THIS IS NOT PRACTICAL, ADEQUATE SUPPORT FOR THE EXCAVATED AREA SHOULD BE PROVIDED TO PREVENT COLLAPSE. WARNING SIGNS & BARRIERS TO PREVENT ACCIDENTAL OR UNAUTHORISED ACCESS TO ALL EXCAVATIONS SHOULD BE PROVIDED

FOR BUILDINGS WITH ENCLOSED SPACES WHERE MAINTENANCE OR OTHER ACCESS MAY BE REQUIRED. ENCLOSED SPACES WITHIN THIS BUILDING MAY PRESENT A RISK TO PERSONS ENTERING FOR CONSTRUCTION, MAINTENANCE, OR ANY OTHER PURPOSE, THE DESIGN DOCUMENTATION CALLS FOR WARNING SIGNS & BARRIERS TO UNAUTHORISED ACCESS. THESE SHOULD BE MAINTAINED THROUGHOUT THE LIFE OF THE BUILDING, WHERE WORKERS ARE REQUIRED TO ENTER ENCLOSED SPACES, AIR TESTING EQUIPMENT & PERSONAL PROTECTIVE EQUIPMENT SHOULD BE PROVIDED.

## SMAIL SPACES

FOR BUILDINGS WITH SMALL SPACES WHERE MAINTENANCE OR OTHER ACCESS MAY BE REQUIRED. SOME SMALL SPACES WITHIN THIS BUILDING WILL REQUIRE ACCESS BY CONSTRUCTION OR MAINTENANCE WORKERS. THE DESIGN DOCUMENTATION CALLS FOR WARNING SIGNS & BARRIERS TO UNAUTHORISED ACCESS. THESE SHOULD BE MAINTAINED THROUGHOUT THE LIFE OF THE BUILDING, WHERE WORKERS ARE REQUIRED TO ENTER SMALL SPACES THEY SHOULD BE SCHEDULED SO THAT ACCESS IS FOR SHORT PERIODS. MANUAL LIFTING & OTHER MANUAL ACTIVITY SHOULD BE RESTRICTED IN SMALL SPACES.

#### **HAZARDOUS SUBSTANCES**

ALTHOUGH DURING SPECIFICATION CARE HAS BEEN TAKEN TO ENSURE THE USE OF NON HAZARDOUS MATERIALS THE POSSIBILITIES OF EXPOSURE STILL EXIST & AS SUCH ALL PRECAUTIONS SHOULD BE MADE DURING USE IN ACCORDANCE WITH MANUFACTURERS SPECIFICATIONS.

#### ASBESTOS

FOR ALTERATIONS TO A BUILDING CONSTRUCTED PRIOR TO 1990: IF THIS EXISTING BUILDING WAS CONSTRUCTED PRIOR TO:

1990- IT THEREFORE IS LIKELY TO CONTAIN ASBESTOS

1986- IT THEREFORE MAY CONTAIN ASBESTOS EITHER IN CLADDING MATERIAL OR IN FIRE RETARDANT INSULATION MATERIAL. IN EITHER CASE, THE BUILDER SHOULD CHECK & IF NECESSARY, TAKE APPROPRIATE ACTION BEFORE DEMOLISHING, CUTTING, SANDING, DRILLING OR OTHERWISE DISTURBING THE EXISTING

#### POWDERED MATERIALS

MANY MATERIALS USED IN THE CONSTRUCTION OF THIS BUILDING CAN CAUSE HARM IF INHALED IN POWDERED FORM. PERSONS WORKING ON OR IN THE BUILDING DURING CONSTRUCTION, OPERATIONAL MAINTENANCE OR DEMOLITION SHOULD ENSURE GOOD VENTILATION & WEAR PERSONAL PROTECTIVE EQUIPMENT INCLUDING PROTECTION AGAINST INHALATION WHILE USING POWDERED MATERIAL OR WHEN SANDING, DRILLING, CUTTING OR OTHERWISE DISTURBING OR CREATING POWDERED MATERIAL.

THE DESIGN OF THIS BUILDING MAY INCLUDE PROVISION FOR THE INCLUSION OF TREATED TIMBER WITHIN THE STRUCTURE, DUST OR FUMES FROM THIS MATERIAL CAN BE HARMFUL, PERSONS WORKING ON OR IN THE BUILDING DURING CONSTRUCTION, OPERATIONAL MAINTENANCE OR DEMOLITION SHOULD ENSURE GOOD VENTILATION & WEAR PERSONAL PROTECTIVE EQUIPMENT INCLUDING PROTECTION AGAINST INHALATION OF HARMFUL MATERIAL WHEN SANDING, DRILLING, CUTTING OR USING TREATED TIMBER IN ANY WAY THAT MAY CAUSE HARMFUL MATERIAL TO BE RELEASED DO NOT BURN TREATED TIMBER.

MANY TYPES OF GLUE, SOLVENTS, SPRAY PACKS, PAINTS, VARNISHES & SOME CLEANING MATERIALS & DISINFECTANTS HAVE DANGEROUS EMISSIONS. AREAS WHERE THESE ARE USED SHOULD BE KEPT WELL VENTILATED WHILE THE MATERIAL IS BEING LISED & FOR A PERIOD AFTER INSTALLATION PERSONAL PROTECTIVE EQUIPMENT MAY ALSO BE REQUIRED. THE MANUFACTURER'S RECOMMENDATIONS FOR USE MUST BE CAREFULLY CONSIDERED AT ALL TIMES.

#### SYNTHETIC MINERAL FIBRE

FIBREGLASS, ROCKWOOL, CERAMIC AND OTHER MATERIAL USED FOR THERMAL OR SOUND INSULATION MAY CONTAIN SYNTHETIC MINERAL FIBRE WHICH MAY BE HARMFUL IF INHALED OR IF IT COMES IN CONTACT WITH THE SKIN, EYES OR OTHER SENSITIVE PARTS OF THE BODY. PERSONAL PROTECTIVE EQUIPMENT INCLUDING PROTECTION AGAINST INHALATION OF HARMFUL MATERIAL SHOULD BE USED WHEN INSTALLING REMOVING OR WORKING NEAR BUILK INSULIATION MATERIAL

THIS BUILDING MAY CONTAIN TIMBER FLOORS WHICH HAVE AN APPLIED FINISH. AREAS WHERE FINISHES ARE APPLIED SHOULD BE KEPT WELL VENTILATED DURING SANDING & APPLICATION & FOR A PERIOD AFTER INSTALLATION. PROTECTIVE EQUIPMENT MAY ALSO BE REQUIRED. THE MANUFACTURER'S RECOMMENDATIONS FOR USE MUST BE CAREFULLY CONSIDERED AT ALL TIMES

THROUGHOUT THE CONSTRUCTION PERIOD STORAGE & USE OF HAZARDOUS MATERIALS FOR THE ASSOCIATED BUILD IS TO BE THE RESPONSIBILITY OF THE PRINCIPAL CONTRACTOR.

### **PUBLIC ACCESS**

PUBLIC ACCESS TO CONSTRUCTION & DEMOLITION SITES & TO AREAS UNDER MAINTENANCE CAUSES RISK TO WORKERS & PUBLIC. WARNING SIGNS & SECURE BARRIERS TO UNAUTHORISED ACCESS SHOULD BE PROVIDED. WHERE ELECTRICAL INSTALLATIONS, EXCAVATIONS, PAINT OR LOOSE MATERIALS ARE PRESENT THEY SHOULD BE SECURED WHEN NOT FULLY SUPERVISED.

## **AMENITIES & FACILITIES**

ACCESS TO EXISTING AMENITIES ARE TO BE RESTRICTED TO CLIENT'S PERSONNEL & VISITING CLIENTELE ONLY. IT IS THE RESPONSIBILITY OF THE PRINCIPAL CONTRACTOR TO PROVIDE & MAINTAIN AMENITIES & FACILITIES AS REQUIRED, INCLUDING STORAGE, FIST AID, RESTROOMS, MEAL AREAS & DRINKING WATER.

### MOVEMENT OF PEOPLE & MATERIALS

THROUGHOUT CONSTRUCTION & THE LIFECYCLE OF THE RUILDING SAFE ACCESS & EGRESS INCLUDING FOR THOSE WITH A DISABILITY IS TO BE MAINTAINED THROUGHOUT THE BUILDING & SITE. THE EXISTING FRONT ENTRANCE TO THE BUILDING IS DEEMED TO BE THE ACCESSIBLE ROUTE IN & OUT OF THE BUILDING, & AS SUCH SHOULD BE MAINTAINED CLEAR & FREE OF CONSTRUCTION MATERIALS DURING THE CONSTRUCTION

TRAFFIC MANAGEMENT DURING THE CONSTRUCTION & LIFECYCLE OF THE BUILDING IS TO BE THE

EXCLUSION ZONES ARE TO BE SET IN PLACE BY ESSENTIAL ENERGY DURING CONSTRUCTION, & AS SUCH MOVEMENT WITHIN THESE AREAS ARE TO BE PROHIBITED EXCEPT BY WRITTEN PERMISSION OF THE CLIENT.

SITE SECURITY DURING CONSTRUCTION IS TO BE SHARED BY THE PRINCIPAL CONTRACTOR & CLIENT. SECURITY FENCING SHALL BE PROVIDED AROUND THE PERIMETER OF THE CONSTRUCTION SITE & ANY ADDITIONAL PRECAUTIONARY MEASURES TAKEN, AS MAY BE NECESSARY TO PREVENT UNAUTHORISED ENTRY TO THE SITE AT ALL TIMES DURING THE CONSTRUCTION PERIOD.

### OTHER HIGH RISK ACTIVITY

ALL ELECTRICAL WORK SHOULD BE CARRIED OUT IN ACCORDANCE WITH CODE OF PRACTICE: MANAGING ELECTRICAL RISKS AT THE WORKPLACE, AS/NZ 3012 & ALL LICENSING REQUIREMENTS.

ALL WORK LISING PLANT SHOULD BE CARRIED OUT IN ACCORDANCE WITH CODE OF PRACTICE: MANAGING RISKS OF PLANT AT THE WORKPLACE. ALL WORK SHOULD BE CARRIED OUT IN ACCORDANCE WITH CODE OF PRACTICE: MANAGING NOISE & PREVENTING HEARING LOSS AT WORK. DUE TO THE HISTORY OF SERIOUS INCIDENTS IT IS RECOMMENDED THAT PARTICULAR CARE BE EXERCISED WHEN UNDERTAKING WORK INVOLVING STEEL CONSTRUCTION & CONCRETE PLACEMENT. ALL THE ABOVE APPLIES.

THESE NOTES DO NOT REPRESENT A COMPREHENSIVE STATEMENT OF THE LAW AS IT APPLIES TO PARTICULAR PROBLEMS OR TO INDIVIDUALS OR AS A SUBSTITUTE FOR LEGAL ADVICE. YOU SHOULD SEEK INDEPENDENT LEGAL ADVICE IF YOU NEED ASSISTANCE ON THE APPLICATION OF THE LAW TO YOUR SITUATION

INFORMATION ON THE LATEST LAWS CAN BE CHECKED BY VISITING THE NSW LEGISLATION WEBSITE (WWW.LEGISLATION.NSW.GOV.AU).



## **EVOLVE BUILDING DESIGN**

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CLIENT: AMY & DAN CLAYPOLE

PROJECT No: 00031

REVISION: 5

PROJECT: PROPOSED RESIDENCE 43 LECONFIELD DRIVE BOMBIRA

DRAWING TITLE: SAFE DESIGN OF STRUCTURES NOTES

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