

AHMEDI

PROPOSED DETACHED DUAL OCCUPANCY

LOT 920, 19 SHEARMAN STREET CAERLEON, NSW, 2850



| LOCALITY PLAN | SCALE: 1:1 (A3)

DRAWING SCHEDULE

0501-A 01 TITLE & LOCATION PLAN 0501-A 02 BASIX CERTIFICATE COMMITMENTS 0501-A 03 SITE, SUBDIVISION & LANDSCAPE PLAN 0501-A 04 FLOOR PLAN - DWELLING ONE 0501-A 05 FLOOR PLAN - DWELLING TWO 0501-A 06 ELEVATIONS - DWELLING ONE 0501-A 07 ELEVATIONS - DWELLING TWO 0501-A 08 TYPICAL SECTION & GENERAL NOTES 0501-A 09 ELECTRICAL & MECHANICAL PLAN - DWELLING ONE

0501-A 10 ELECTRICAL & MECHANICAL PLAN - DWELLING TWO

RE-ISSUED FOR DA APPROVAL

Date Description

6/12/23 ISSUED FOR REVIEW 16/05/24 ISSUED FOR REVIEW

22/08/24 ISSUED FOR DA APPROVAL 4/10/24 ISSUED FOR DA APPROVAL 18/11/24 RE-ISSUED FOR DA APPROVAL

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- SEPERATE SPECIFICATION DOCUMENTS
- STRUCTURAL ENGINEERS DOCUMENTATION
- PCA DOCUMENTS (WHERE APPLICABLE)
- BASIX CERTIFICATE
- ALL RELEVANT CODES, STANDARDS &
- APPROVALS

BUILDING DESIGNERS ASSOCIATION OF AUSTRALIA

LYNCH BUILDING GROUP

AHMEDI

PROPOSED DUAL OCCUPANCY AT 19 SHEARMAN STREET, CAERLEON (LOT 920)



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Drawing Title: TITLE & LOCATION PLAN

Design LBG Sheet **01** of **10** Drawn G.HACKETT

Check J.LYNCH

Drawing Number

0501 - A01

Revision G

BASIX CERTIFICATE COMMITMENTS: DWELLING ONE

THERMAL COMMITMENTS

THE APPLICANT MUST COMPLY WITH THE COMMITMENTS LISTED BELOW IN CARRYING OUT THE DEVELOPMENT OF THE DWELLING.

FINDR WALLS CELLING/RODE.

CONSTRUCTION FLOOR - CONCRETE SLAB ON GROUND	ADD. INSULATION REQ'D. (R-VALUE) NIL	OTHER SPECIFICATIONS
EXTERNAL WALL: BRICK VENEER	2.94 (OR 3.50 INCLUDING CONSTRUCTION)	MEDIUM
EXTERNAL WALL: FRAMED / CLADDED	3.00 (OR 3.50 INCLUDING CONSTRUCTION)	(SOLAR ABSORBANCE 0.48-0.7) MEDIUM
INTERNAL WALL: SHARED WITH GARAGE	1.08 (OR 1.50 INCLUDING CONSTRUCTION)	(SOLAR ABSORBANCE 0.48-0.7)
CEILING & ROOF - FLAT	CEILING - 5.5 (UP)	UNVENTILATED
CEILING/PITCHED ROOF	ROOF - FOIL BACKED BLANKET	LIGHT (SOLAR ABSORBANCE <0.38)

ENERGY COMMITMENTS

THE APPLICANT MUST COMPLY WITH THE COMMITMENTS LISTED BELOW IN CARRYING OUT THE DEVELOPMENT OF THE DWELLING

HOT WATER:	THE APPLICANT MUST INSTALL A GAS INSTANTANEOUS SYSTEM WITH A MIN. RATING OF 6 STARS

THE APPLICANT MUST INSTALL IN AT LEAST 1 LIVING AREA: 1 PHASE AIR CONDITIONING 4.5 STAR (COLD ZONE) COOLING SYSTEM: THE APPLICANT MUST INSTALL IN ALL BEDROOMS: 1 PHASE AIR CONDITIONING 4.5 STAR (COLD ZONE)

THE APPLICANT MUST INSTALL IN AT LEAST 1 LIVING AREA: 1 PHASE AIR CONDITIONING 4.5 STAR (COLD ZONE) HEATING SYSTEM:

THE APPLICANT MUST INSTALL IN ALL BEDROOMS: 1 PHASE AIR CONDITIONING 4.5 STAR (COLD ZONE)

VENTILATION: IN AT LEAST 1 BATHROOM: INDIVIDUAL FAN, DUCTED TO FACADE OR ROOF; MANUAL SWITCH ON/OFF

KITCHEN: INDIVIDUAL FAN, DUCTED TO FACADE OR ROOF; MANUAL SWITCH ON/OFF

LAUNDRY: NATURAL VENTILATION ONLY

ARTIFICIAL THE APPLICANT MUST ENSURE THAT A MINIMUM OF 80% OF LIGHT FIXTURES ARE FITTED WITH FLUORESCENT,

COMPACT FLUORESCENT OR LIGHT-EMITTING DIODE (LED) LAMPS LIGHTING:

NATURAL THE APPLICANT MUST PROVIDE NATURAL LIGHTING TO THE FOLLOWING;

LIGHTING: - AT LEAST 2 BATHROOMS/TOILETS

- THE KITCHEN

THE APPLICANT MUST INSTALL A FIXED OUTDOOR CLOTHES DRYING LINE OTHER:

THE APPLICANT MUST INSTALL A GAS COOKTOP & ELECTRIC OVEN IN THE KITCHEN

GLAZING REQUIREMENTS

THE APPLICANT MUST INSTALL ALL PROPOSED WINDOWS, GLAZED DOORS & SHADING DEVICES AS LISTED BELOW.

WINDOW/DOOR	ORIENTATION	SIZE OVER-S	SHAD SHADING	TYPE
LIVING	NORTH	1.8m x 1.8m -	- E: 600mm A/H: 0mm	ALUMINIUM, DOUBLE GLAZED (U-VALUE: <=2.5, SHGC: 0.60)
DINING	NORTH	2.0m x 2.7m -	- E: 3300mm A/H: 150mm	ALUMINIUM, DOUBLE GLAZED (U-VALUE: <=2.5, SHGC: 0.60)
DINING	EAST	1.8m x 1.8m -	- E: 600mm A/H: 0mm	ALUMINIUM, SINGLE GLAZED (U-VALUE: <=6.0, SHGC: 0.74)
KITCHEN	EAST	1.1m x 1.5m -	- E: 600mm A/H: 0mm	ALUMINIUM, SINGLE GLAZED (U-VALUE: <=6.0, SHGC: 0.74)
BED 2	EAST	1.8m x 1.8m -	- E: 600mm A/H: 0mm	ALUMINIUM, SINGLE GLAZED (U-VALUE: <=6.0, SHGC: 0.74)
ENSUITE	SOUTH	0.6m x 1.5m -	- E: 600mm A/H: 0mm	ALUMINIUM, SINGLE GLAZED (U-VALUE: <=6.0, SHGC: 0.74)
BED 1	SOUTH	1.8m x 1.8m -	- E: 600mm A/H: 0mm	ALUMINIUM, SINGLE GLAZED (U-VALUE: <=6.0, SHGC: 0.74)
BED 3	WEST	2.1m x 0.8m -	- E: 750mm A/H: 150mm	ALUMINIUM, SINGLE GLAZED (U-VALUE: <=6.0, SHGC: 0.74)
BATH	WEST	0.7m x 1.5m -	- E: 600mm A/H: 0mm	ALUMINIUM, SINGLE GLAZED (U-VALUE: <=6.0, SHGC: 0.74)

WATER COMMITMENTS

THE APPLICANT MUST COMPLY WITH THE COMMITMENTS LISTED BELOW IN CARRYING OUT THE DEVELOPMENT OF THE DWELLING.

FIXTURES:	THE APPLICANT MUST INSTALL	. SHOWERHEADS WITH A MIN. RATING OF	4 STAR (>4.5<=6L/min).

THE APPLICANT MUST INSTALL TOILET FLUSHING SYSTEMS WITH A MIN. RATING OF 4 STAR.

THE APPLICANT MUST INSTALL TAPS WITH A MIN. RATING OF 4 STAR IN THE KITCHEN. THE APPLICANT MUST INSTALL BASIN TAPS WITH A MIN. RATING OF 4 STAR IN EACH BATHROOM.

ALTERNATIVE THE APPLICANT MUST INSTALL A RAINWATER TANK OF 2,000 LITRES MIN. TO REGULATORY REQUIREMENTS.

TO COLLECT RUNOFF FROM 222m² ROOF AREA MIN. WATER SOURCE:

NOTE:

THE APPLICANT MUST CONNECT THE RAINWATER TANK TO:

- THE COLD WATER TAP THAT SUPPLIES EACH CLOTHES WASHER;
- AT LEAST ONE OUTDOOR TAP IN THE DEVELOPMENT

DWELLING TWO BASIX CERTIFICATE COMMITMENTS:

THERMAL COMMITMENTS

THE APPLICANT MUST COMPLY WITH THE COMMITMENTS LISTED BELOW IN CARRYING OUT THE DEVELOPMENT OF THE DWELLING.

FLOOR, WALLS, CEILING/ROOF:

CONSTRUCTION ADD. INSULATION REQ'D. (R-VALUE) OTHER SPECIFICATIONS

FLOOR - CONCRETE SLAB ON GROUND

EXTERNAL WALL: BRICK VENEER 2.94 (OR 3.50 INCLUDING CONSTRUCTION) MEDIUM

EXTERNAL WALL: FRAMED / CLADDED 3.00 (OR 3.50 INCLUDING CONSTRUCTION)

(SOLAR ABSORBANCE 0.48-0.7) INTERNAL WALL: SHARED WITH GARAGE 1.08 (OR 1.50 INCLUDING CONSTRUCTION)

CEILING & ROOF - FLAT CEILING - 5.5 (UP) UNVENTILATED

CEILING/PITCHED ROOF LIGHT (SOLAR ABSORBANCE < 0.38) ROOF - FOIL BACKED BLANKET

ENERGY COMMITMENTS

THE APPLICANT MUST COMPLY WITH THE COMMITMENTS LISTED BELOW IN CARRYING OUT THE DEVELOPMENT OF THE DWELLING.

THE APPLICANT MUST INSTALL A GAS INSTANTANEOUS SYSTEM WITH A MIN. RATING OF 6 STARS

COOLING SYSTEM: THE APPLICANT MUST INSTALL IN AT LEAST 1 LIVING AREA: 1 PHASE AIR CONDITIONING 4.5 STAR (COLD ZONE)

THE APPLICANT MUST INSTALL IN ALL BEDROOMS: 1 PHASE AIR CONDITIONING 4.5 STAR (COLD ZONE)

THE APPLICANT MUST INSTALL IN AT LEAST 1 LIVING AREA: 1 PHASE AIR CONDITIONING 4.5 STAR (COLD ZONE) HEATING SYSTEM: THE APPLICANT MUST INSTALL IN ALL BEDROOMS: 1 PHASE AIR CONDITIONING 4.5 STAR (COLD 70NE)

VENTILATION: IN AT LEAST 1 BATHROOM: INDIVIDUAL FAN. DUCTED TO FACADE OR ROOF: MANUAL SWITCH ON/OFF

KITCHEN: INDIVIDUAL FAN, DUCTED TO FACADE OR ROOF; MANUAL SWITCH ON/OFF LAUNDRY: NATURAL VENTILATION ONLY

ARTIFICIAL THE APPLICANT MUST ENSURE THAT A MINIMUM OF 80% OF LIGHT FIXTURES ARE FITTED WITH FLUORESCENT,

COMPACT FLUORESCENT OR LIGHT-EMITTING DIODE (LED) LAMPS. LIGHTING:

NATURAL THE APPLICANT MUST PROVIDE NATURAL LIGHTING TO THE FOLLOWING;

LIGHTING: - AT LEAST 2 BATHROOMS/TOILETS

- THE KITCHEN

THE APPLICANT MUST INSTALL A FIXED OUTDOOR CLOTHES DRYING LINE OTHER:

THE APPLICANT MUST INSTALL A GAS COOKTOP & ELECTRIC OVEN IN THE KITCHEN

GLAZING REQUIREMENTS

THE APPLICANT MUST INSTALL ALL PROPOSED WINDOWS, GLAZED DOORS & SHADING DEVICES AS LISTED BELOW.

WINDOW/DOOR	ORIENTATION	SIZE C	OVER-SHAD	SHADING	TYPE
LIVING	NORTH	1.6m x 2.5m	-	E: 600mm A/H: 0mm	ALUMINIUM, DOUBLE GLAZED (U-VALUE: <=2.5, SHGC: 0.60)
LIVING	EAST	1.8m x 1.8m	-	E: 600mm A/H: 0mm	ALUMINIUM, SINGLE GLAZED (U-VALUE: <=6.0, SHGC: 0.74)
DINING	EAST	2.0m x 2.4m	-	E: 3150mm A/H: 150mm	ALUMINIUM, SINGLE GLAZED (U-VALUE: <=6.0, SHGC: 0.74)
KITCHEN	EAST	1.1m x 1.5m	-	E: 600mm A/H: 0mm	ALUMINIUM, SINGLE GLAZED (U-VALUE: <=6.0, SHGC: 0.74)
ENSUITE	EAST	0.6m x 1.5m	-	E: 600mm A/H: 0mm	ALUMINIUM, SINGLE GLAZED (U-VALUE: <=6.0, SHGC: 0.74)
BED 1	EAST	1.8m x 2.1m	-	E: 600mm A/H: 0mm	ALUMINIUM, SINGLE GLAZED (U-VALUE: <=6.0, SHGC: 0.74)
BATHROOM	SOUTH	1.2m x 1.5m	-	E: 600mm A/H: 0mm	ALUMINIUM, SINGLE GLAZED (U-VALUE: <=6.0, SHGC: 0.74)
BED 2	SOUTH	1.5m x 1.5m	-	E: 600mm A/H: 0mm	ALUMINIUM, SINGLE GLAZED (U-VALUE: <=6.0, SHGC: 0.74)
BED 3	WEST	1.5m x 1.5m	-	E: 600mm A/H: 0mm	ALUMINIUM, SINGLE GLAZED (U-VALUE: <=6.0, SHGC: 0.74)

THE APPLICANT MUST COMPLY WITH THE COMMITMENTS LISTED BELOW IN CARRYING OUT THE DEVELOPMENT OF THE DWELLING.

THE APPLICANT MUST INSTALL SHOWERHEADS WITH A MIN. RATING OF 4 STAR (>4.5<=6L/min). FIXTURES:

> THE APPLICANT MUST INSTALL TOILET FLUSHING SYSTEMS WITH A MIN. RATING OF 4 STAR. THE APPLICANT MUST INSTALL TAPS WITH A MIN. RATING OF 4 STAR IN THE KITCHEN.

THE APPLICANT MUST INSTALL BASIN TAPS WITH A MIN. RATING OF 4 STAR IN EACH BATHROOM.

ALTERNATIVE THE APPLICANT MUST INSTALL A RAINWATER TANK OF 2,000 LITRES MIN. TO REGULATORY REQUIREMENTS. TO COLLECT RUNOFF FROM 185m² ROOF AREA MIN.

WATER SOURCE: THE APPLICANT MUST CONNECT THE RAINWATER TANK TO:

- THE COLD WATER TAP THAT SUPPLIES FACH CLOTHES WASHER

- AT LEAST ONE OUTDOOR TAP IN THE DEVELOPMENT.

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PROPOSED DUAL OCCUPANCY Project: AT 19 SHEARMAN STREET. CAERLEON (LOT 920)



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(SOLAR ABSORBANCE 0.48-0.7)

Design LBG Sheet **02** of **10**


Drawing Title: BASIX CERTIFICATE COMMITMENTS

Drawing Number


0501 - A02

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Revision

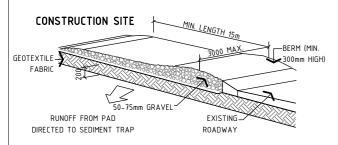

DETAIL PLAN: CONSTRUCTION ENTRY / EXIT NOT TO SCALE

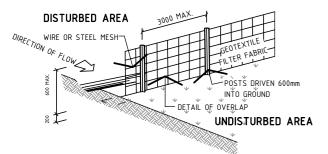

DETAIL PLAN: SEDIMENT FENCE

EROSION & SEDIMENT CONTROL NOTES

- 1. ALL EROSION & SEDIMENT CONTROL STRUCTURES ARE TO BE INSTALLED PRIOR TO SITE DISTURBANCE.
- 2. ALL SEDIMENT CONTROL STRUCTURES TO BE INSPECTED & MAINTAINED BY THE BUILDER AT LEAST WEEKLY. IF STRUCTURES ARE TO BE REMOVED, THEY ARE TO BE REINSTALLED & INSPECTED BY THE BUILDER
- 3. ALL SEDIMENT RETAINING STRUCTURES TO BE CLEANED ON REACHING 50% STORAGE CAPACITY & SPREAD ON DISTURBED AREA
- 4. ACCESS TO SITE IS TO BE THROUGH USE OF THE ENTRY/EXIT SHOWN
- 5. ALL VEGETATION OUTSIDE OF THE CONSTRUCTION AREA IS TO BE RETAINED WHERE POSSIBLE (VEGETATION BUFFER)
- 6. STOCKPILES OF ERODIBLE BUILDING MATERIALS INCLUDING SAND & SOIL MUST BE LOCATED WITHIN THE DESIGNATED MATERIAL STOCKPILE AREA (MSA) & PROTECTED WITH SEDIMENT FENCE OR STRAW BALE SEDIMENT FILTERS. THE BUILDER MAY NOMINATE FURTHER STORAGE AREAS WITHIN
- 7. NO STORAGE OF MATERIALS OR VECHICLE MOVEMENTS ARE TO OCCUR OUTSIDE THE SITE BOUNDARIES

SITEWORK NOTES

- 1. CONFIRM ALL DIMENSIONS ON SITE TO EXISTING RESIDENCE PRIOR TO COMMENCEMENT OF ANY WORK
- 2. THIS PLAN DOES NOT PROVIDE SPECIFIC LANDSCAPE PLANTING LOCATIONS
- 3. THE EXACT LOCATION OF UNDERGROUND AND ABOVEGROUND SERVIES SHALL BE PROVEN ON SITE. NO GUARANTEE IS GIVEN THAT ALL EXISTING SERVICES ARE SHOWN.
- 4. THIS DRAWING SET TO BE READ IN CONJUNCTION WITH THE SPECIFICATION PROVIDED.
- 5. BEWARE OF EXISTING SERVICES. CONFIRM LOCATIONS PRIOR TO FXCAVATION TAKE EXTREME CARE

SITE, SUBDIVISION & LANDSCAPE PLAN

SCALE: 1:200 (A3)

LEGEND:

TEMPORARY SITE MATERIAL DISPOSAL AREA DURING CONSTRUCTION. TO BE PROTECTED BY A SEDIMENT FENCE OR STRAW BALE FILTER

SITE ACCESS DURING CONSTRUCTION

SITE COVERAGE

19 SHEARMAN STREET, CAERLEON	902.3 m ²
SITE COVERAGE	
TOTAL GFA INCLUDING PORCH & ALFRESCO AREAS	318 m ² 35.24%
LANDSCAPING	
LANDSCAPING - INCLUDING GRAVEL AREAS LESS TOTAL DRIVEWAY & PATHWAYS	584.3 m ² 57.95 m ²

	526.35 m ²
	58.33 %
PRIVATE OPEN SPACE (P.O.S)	
DWELLING ONE	91.73 m²
DWELLING TWO	112.89 m ²
	204.62 m ²

SUBDIVISION NOTES

LOT 920, 19 SHEARMAN STREET, CAERLEON DP1274170 - ZONING R1 GENERAL RESIDENTIAL

TOTAL LOT 920 AREA	902.3 m ²
PROPOSED LOT 1 (DWELLING ONE)	477 m²
PROPOSED LOT 2 (DWELLING TWO)	425.3 m ²

- CONFIRM ALL DIMENSIONS BACK TO SPECIFIC SURVEY PLANS PRIOR TO COMMENCEMENT OF ANY WORKS
- PROPOSED DIVIDING SUBDIVISON BOUNDARY IS APPROXIMATE ONLY AND TO BE CONFIRMED AS ABOVE
- PROPOSED LOT AREAS ARE APPROXIMATE ONLY & SHOULD BE READ IN CONJUCTION WITH SPECIFIC SURVEY PLANS

LANDSCAPING DETAILS

SMALL SHRUBS TO 1.0m HIGH

- SURFER BOY (PHORIUM)
- BRONZE BABY (PHORIUM)
- GOLF BABY (PITTOSPORUM)


SMALL ORNAMENTAL TREES TO 3.0m HIGH

- MANCHURIAN PEAR (PYRUS USSURIENSIS)

CONSULT LOCAL NURSERY FOR AVAILABILITY AND SUSTABILITY OF SPECIES LISTED & SUBSTITUTE SIMILAR PLANTING IF REQUIRED MULCH BEDS WITH WOODCHIP OR PEBBLES & FILL OUT OR LINE BEDS WITH GROUND COVERS OR SIMILAR SMALL PLANTS. EDGE BEDS WITH INSITU FORMED CONCRETE ROLLED EDGE, SLEEPRS, MASONARY BLOCK EDGING OR SIMILAR AS SELECTED.

KIKUYU TURF TO ALL AREAS, UNLESS GRAVEL IS STATED AND DISPLAYED

AT BUILDERS DISCRETION SUBSTITUTE SHRUBS AND TREES MAY BE USED TO REPLACE THIS ABOVE MENTIONED SPECIES AND ALSO THE LOCATION OF GARDEN BEDS, SHOULD THE SITE LEAD TO AN ALTERNATIVE / MORE SUITABLE OPTION.

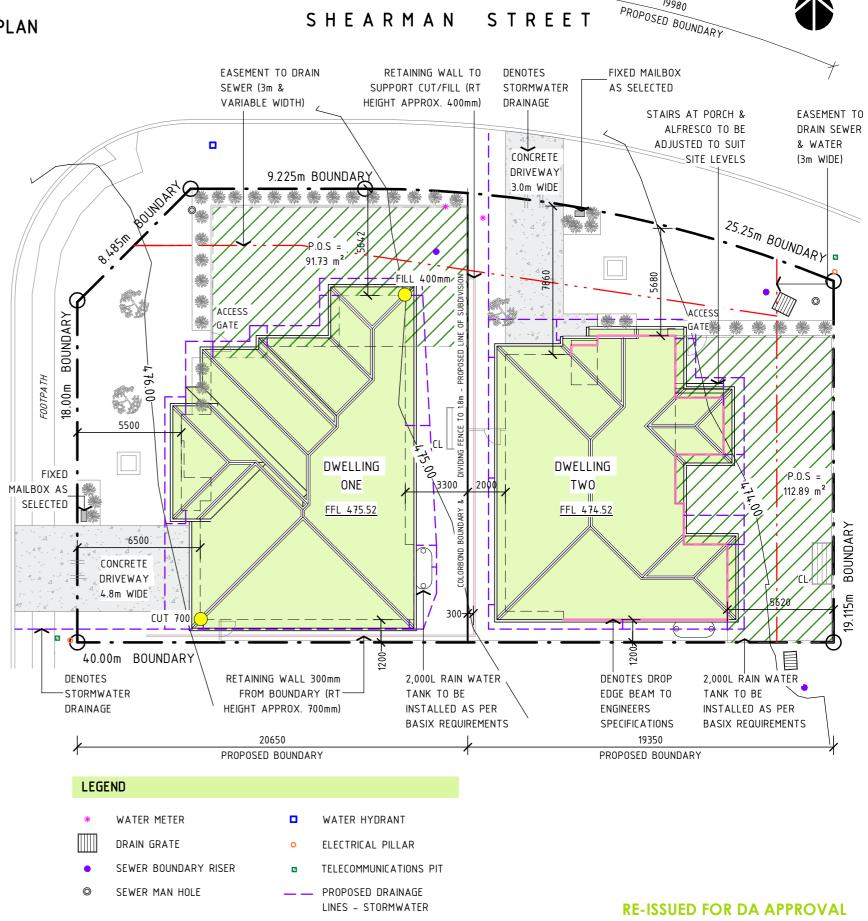

SHEARMAN STREET

14580 PROPOSED BOUNDARY

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LYNCH BUILDING GROUP

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PROPOSED DUAL OCCUPANCY AT 19 SHEARMAN STREET. CAERLEON (LOT 920)



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Drawing Title: SITE, SUBDIVISION & LANDSCAPE PLAN

Design LBG Drawn G.HACKETT

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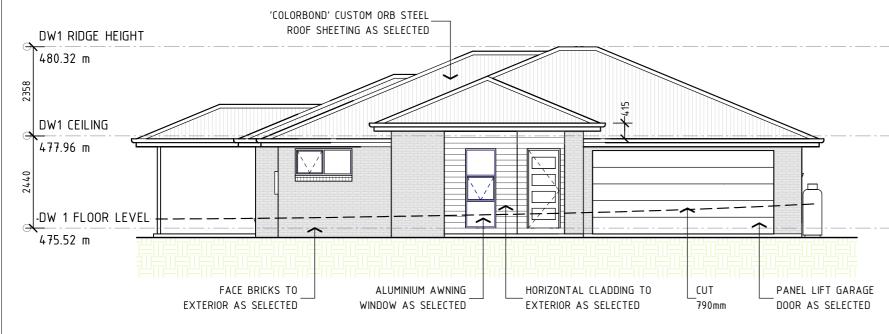
Sheet **03** of **10** Drawing Number


0501 - A03

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Revision


DWELLING ONE



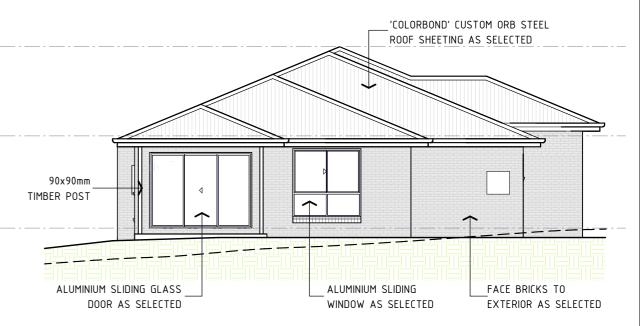

 $05 \mid {\substack{\mathsf{ELEVATION:}\\\mathsf{SCALE:} \quad 1 \,:\, 100 \quad (\mathsf{A3})}} \mathsf{west} \,\, \mathsf{facade}$

| ELEVATION: NORTH FACADE | SCALE: 1:100 (A3)

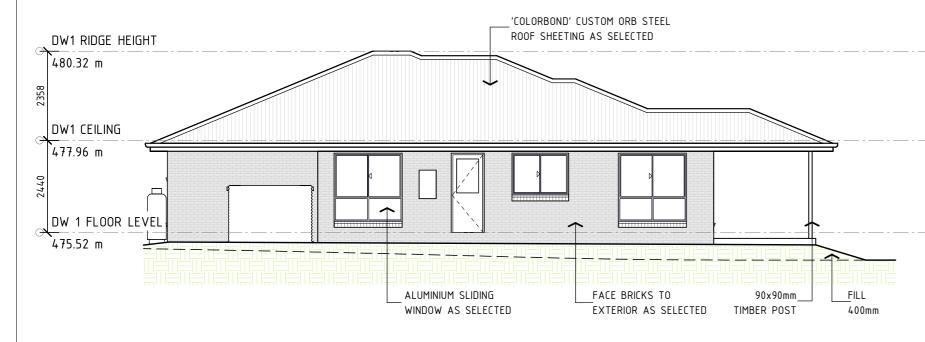

'COLORBOND' CUSTOM ORB STEEL ROOF SHEETING AS SELECTED PROPOSED FACEBRICK AS ALUMINIUM SLIDING NATURAL GROUND LINE SELECTED WINDOW AS SELECTED GROUND LINE

07 | ELEVATION: EAST FACADE | SCALE: 1:100 (A3)

08 | ELEVATION: SOUTH FACADE | SCALE: 1:100 (A3)

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LYNCH BUILDING GROUP

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PROPOSED DUAL OCCUPANCY AT 19 SHEARMAN STREET, CAERLEON (LOT 920)



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† 02 6372 6054 e projects@lynchbuildinggroup.com.au

Drawing Title: ELEVATIONS - DWELLING ONE


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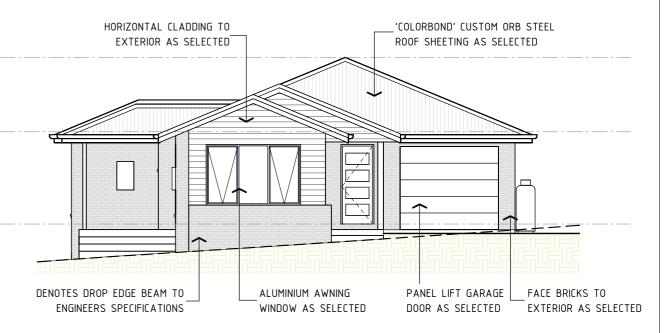
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Sheet **06** of **10** Drawing Number

0501 - A06

DWELLING TWO



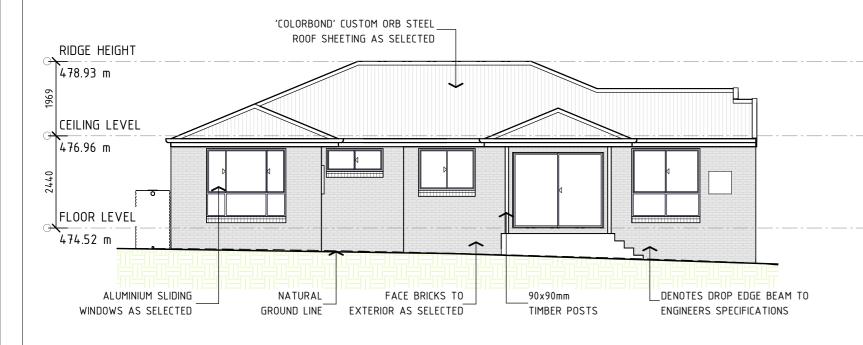

$09 \mid {\substack{\mathsf{ELEVATION:}\\\mathsf{SCALE:} \quad 1: \, 100 \quad (\mathsf{A3})}} \mathsf{EAST} \; \mathsf{FACADE}$



WINDOWS AS SELECTED

| ELEVATION: NORTH FACADE | SCALE: 1:100 (A3)

'COLORBOND' CUSTOM ORB STEEL ROOF SHEETING AS SELECTED CUT _ALUMINIUM SLIDING FACEBRICK AS NATURAL WINDOWS AS SELECTED SELECTED GROUND LINE 490mm

| **ELEVATION**: SOUTH FACADE SCALE: 1:100 (A3)

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SCALE: 1:100 (A3)

ELEVATION: WEST FACADE

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BUILDING DESIGNERS ASSOCIATION OF AUSTRALIA

LYNCH BUILDING GROUP

SELECTED

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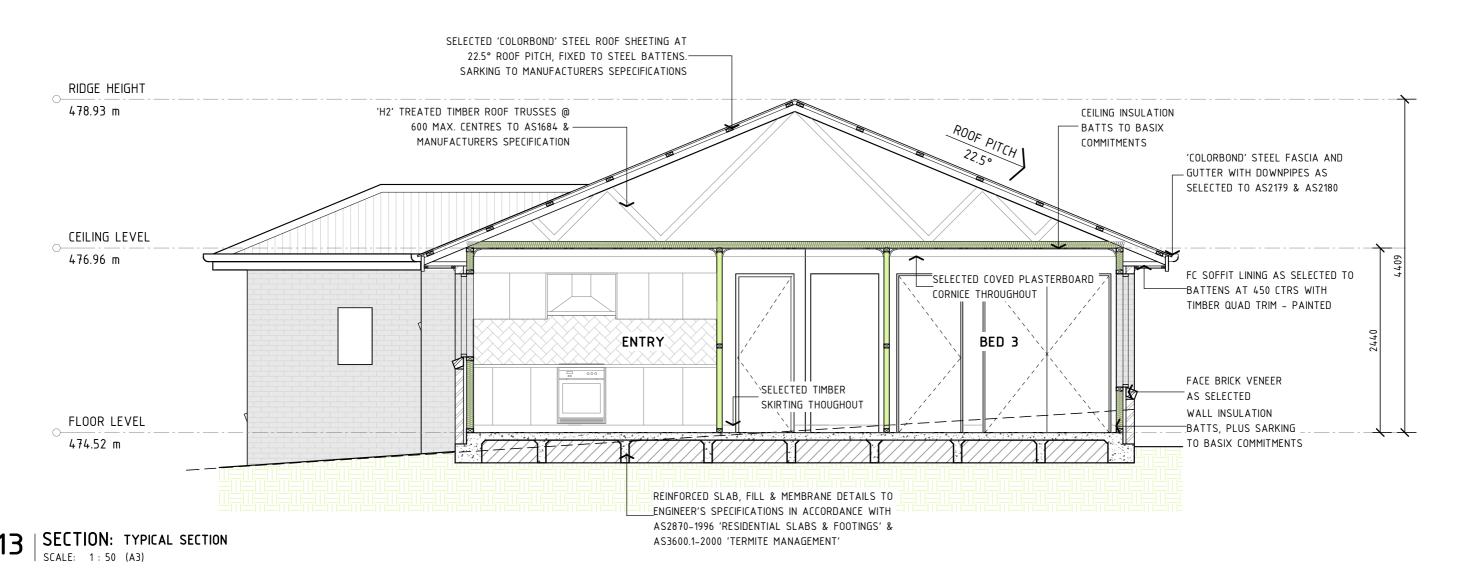
Drawing Title: ELEVATIONS - DWELLING TWO

Design LBG

Sheet **07** of **10** Drawing Number

RE-ISSUED FOR DA APPROVAL

0501 - A07



GENERAL NOTES:

- 1. PLANS DOCUMENTED FOR THE EXLUSIVE USE OF THE NOTES CLIENTS BELOW ONLY & SUBJECT TO COPYRIGHT LAWS.
- 2. ALL DIMENSIONS & INFORMATION WITHIN THESE SET OF PLANS ARE DOCUMENTED DUE TO CARE.
- 3. ALL DRAWINGS WITHIN THIS SET OF PLANS SHALL BE READ IN CONJUCTION WITH OTHER CONSULTANTS DRAWINGS, DESIGNS & SPECIFICATIONS & WITH OTHER WRITTEN INSRUCTIONS ISSUED DURING ESTIMATIONS & CONSTRUCTION WITH SELECTED BUILDER.
- 4. ALL DISCREPANCIES SHALL BE REFFERED TO, IN WRITING TO LYNCH BUILDING GROUP FOR A DECISION BEFORE PROCEEDING WITH THE WORK.
- 5. ALL DIMENSIONS ARE IN MILLIMETRES UNLESS STATED OTHERWISE. DIMENSIONS ARE TO STRCUTURAL ELEMENTS OF THE DRAWING & NOT TO FINISHED SURFACES IE. TILING. PLASTERBOARD ETC.
- 6. ALL RELEVANT DIMENSIONS ARE TO BE CONFIRMED BY THE CONCTRACTOR PRIOR TO CONSTRUCTION & FABRICATION WITH REGARDS TO ONSITE & OFF SITE
- 7. TERMITE PROTECTION SHALL BE IN ACCORDANCE WITH AS3660.

- 8. THE RELEVANT SERVICE AUTHORITIES SHALL BE CONSULTED IN REGARDS TO CONFIRMING / CHECKING ALL DIMENSIONS, LEVELS, SERVICES & SITE CONDITIONS PRIOR TO CONSTRUCTION.
- 9. THE RELEVANT STATUTORY AUTHORITIES SHALL BE NOTIFIED & APPROVAL SORT FROM / OBTAINED PRIOR TO CONSTRUCTION, IF & WHEN NECESSARY.
- 10. STUD WALL & TRUSSED ROOF DESIGN, BRACING & TIE DOWN TO SELECTED FRAME & TRUSS MANUFACTURERS ENGINEERED SPECIFICATIONS TO AS1684 WHERE APPLICABLE.
- 11. SHALL NO WIND CLASSIFICATION BE NOTED, CLIEMT TO BE ADVISED BY PCA OR ENGEERING CONSULTANT.
- 12. SITE CLASSIFICATION TO BE DETERMINED BY QUALIFIED GEOTECHNICAL ENGINEER & ALL REINFORCED CONCRETE FOOTINGS & SLABS TO BE CONSTRUCTED TO AS2870
- 13. ALL STORMWATER FROM ROOF TO BE DISPURSED TO REQUIRED DOWNPIPES & TO STREET/RAIN WATER TANK TO AUSTALIAN STANDARDS & PCA REQUIREMENTS.
- 14. A MINIMUM WATER ALLOWANCE SHALL BE PROVIDED FOR RURAL PROPERTIES FOR FIRE FIGHTING PURPOSES AS SPECIFIED BY PCA.

- 15. WHERE A SITE REQUIRES CUT & FILL TO OCCUR OR RETAINING WALLS CONSTRUCTED, ENGINEERS SHALL BE CONSULTED WHERE NECESSARY & BUILDING CONTRACTOR TO ENSURE ALL FINAL LEVELS, GROUND LINES & GRADIENTS DIVERT ALL SURFACE STORM WATER FROM THE PROPOSED RESIDENCE EITHER BY MEANS OF PIPES. DETENTION AREAS OR GRADING TO KERB. NEIGHBOURING PROPERTIES MUST BE TAKEN INTO CONSIDERATION WITH THE DESIGN OF THE FLOW OF THE STORM WATER
- 16. SEWER DRAINAGE LINES TO BE CONNECTED TO SEWER MAIN OR IN CASE OF A RURAL PROPERTY, CONNECTED TO A SEPTIC SYSTEM, IN ACCORDANCE WITH THE RELEVAMT AUSTRALIAN STANDARDS & LOCAL
- 17. A QUALIFIED CONTRACTOR SHALL COMPLETE THE FINAL DRAINAGE LAYOUT TO BE SUBMITTED TO THE LOCAL PCA FOR THEIR RECORDS & APPROVAL
- 18. THE HOT WATER SYSTEM IS AS SPECIFIED WITHIN THE BASIX CERTIFICATE & LOCATION NOTED ON THE FLOOR PLAN.
- 19. WHERE BRICK VENEER CONSTRUCTION IS SPECIFIED, CONTROL JOINTS FOR ARTICULATION MUST BE PROVIDED AT NOMINAL 6.0m MAX. CENTRES OR TO STRUCTURAL ENGINEERS DETAILS.

SECTION NOTES:

- 1. FOR COMPLETE SLAB DETAILS & DESIGN REFER TO ENGINEERS SPECIFICATIONS & DESIGNS.
- 2. TERMITE TREATMENT SHALL BE INCLUDED TO PROTECT AGAINST INFESTATION TO AS3660.1-2000.
- 3. PARTY WALL DETAILS -
 - SEPERATING PARTY WALL MUST NOT BE CROSSED BY TIMBER OR OTHER COMBUSTIBLE BUILDING ELEMENTS WITH THE EXCEPTION OF STEEL ROOFING BATTENS WITH THE DIMENSIONS 75x50mm OR ROOF SARKING MUST ALSO BE PACKED USING FIRE RESISTANT MATERIAL IN ACCORDANCE WITH THE BCA
 - 25mm GYPROCK SHAFT LINER PANEL BETWEEN STEEL "H" WITH 20-40mm OF SEPERATION BETWEEN FRAMES & GYPROCL SHAFT LINER PANEL.
 - STUDS AT 600mm MAX CENTRES
 - 10mm GYPROCK "SUPERCHEK" PLASTERBOARD WALL LINING TO FACE OF PARTY WALL (GYPROCK EWFA 45743 CSR 360 PARTY WALL SYSTEM)
 - SELECT WALL FRAMING WITH R2.7 GOLD WALL INSULATION BATTS TO BE
 - FIRE RESISTANT MINERAL FIRE BLANKET TO BE INSTALLED DIRECTLY ABOVE PART WALL TO UNDERSIDE OF ROOFING IN ACCORDANCE WITH THE BCA

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- PCA DOCUMENTS (WHERE APPLICABLE) ALL RELEVANT CODES, STANDARDS &
- **BUILDING DESIGNERS** ASSOCIATION OF AUSTRALIA

LYNCH BUILDING GROUP

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PROPOSED DUAL OCCUPANCY AT 19 SHEARMAN STREET, CAERLEON (LOT 920)



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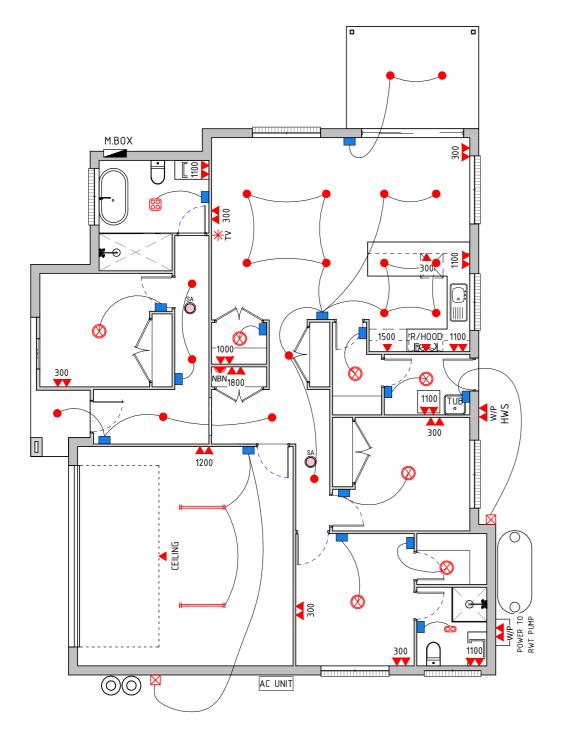
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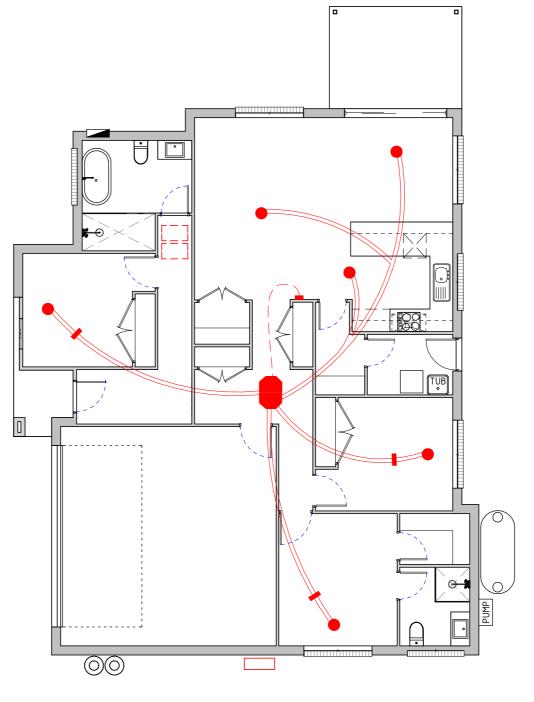
Design LBG

Sheet **08** of **10**

Revision 0501 - A08







14 | DWELLING ONE ELECTRICAL PLAN | SCALE: 1:100 (A3)

DWELLING ONE MECHANICAL PLAN

SCALE: 1:100 (A3)

DAY / NIGHT ZONED

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Drawing Title: ELECTRICAL & MECHANICAL PLAN -

DWELLING ONE

Design LBG Sheet **09** of **10**

ELECTRICAL LEGEND:

DOWN LIGHT

SENSOR LIGHT

STANDARD BATTEN

TASTIC LIGHT - 4 LIGHT

TASTIC LIGHT - 2 LIGHT

TELEVISION OUTLET

NBN POINT LOCATION

LIGHT SWITCH

SMOKE ALARMS

ELECTRICAL NOTES:

MECHANICAL LEGEND:

MECHANICAL NOTES:

REQUIREMENTS.

EXTERNAL DOUBLE POWER POINT

1. ALL ELECTRICAL WORK SHALL BE CARRIED OUT BY A LICENSED CONTRACTOR. ALL WORK SHALL BE IN ACCORDANCE WITH

THE SELECTION OF FITTINGS AND THE LAYOUT TO BE CARRIED OUT BY THE BUILDER & DESIGNED TO THE CLIENTS REQUIREMENTS.

3. ALL APPROVED SMOKE ALARMS/DETECTORS TO BE INSTALLED TO

INDOOR SPLIT SYSTEM AIR CONDITIONER UNIT

MECHANICAL EXHAUST FAN

AS/NZ3012 & ALL LICENSING REQUIREMENTS.

OUTDOOR AIR CONDITIONER UNIT

SUPPLY AIR GRILLS - ROUND

AIR CONDITIONER UNIT IN ROOF SPACE

AIR CONDITIONER CONTROL PANEL / REMOTE

ALL MECHANICAL WORKS REGARDING AIR CONDITIONING SHALL BE CARRIED OUT BY A LICENSED CONSTRACTOR. ALL WORKS SHALL BE

2. THE SELECTION OF FITTINGS AND THE LAYOUT TO BE CONFIRMED BY

GENERAL LAYOUT OF SUPPLY AIR GRILLS ETC IS TO BE VIEWED AS

RE-ISSUED FOR DA APPROVAL

THTE BUILDER & DESIGNED TO THE CLIENTS REQUIREMENTS.

3. AN EXAMPLE ONLY & CAN CHANGE THROUGHOUT INSTALLATION.

IN ACCORDANCE WITH AUS STANDARDS & ALL LICENSING

RETURN AIR GRILLS

AS3786 BY A LICENSED CONTACTOR.

300

SINGLE POWER POINT (DISTANCE ABOVE F.F.L)

DOUBLE POWER POINT (DISTANCE ABOVE F.F.L)

 ■ FLUORESCENT LIGHTS - SINGLE

(14)

(2)

(19)

(2)

(7)

(1)

(1)

(1)

(1)

(2)

(15)

(0)

(2)

Drawing Number Drawn G.HACKETT 0501 - A09 G Check J.LYNCH

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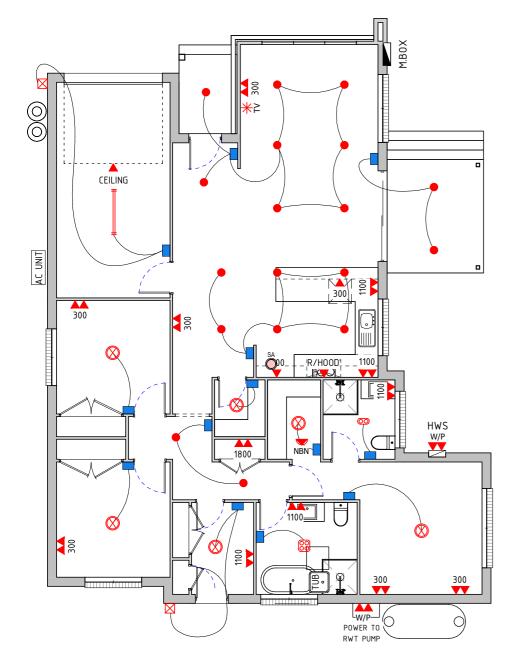
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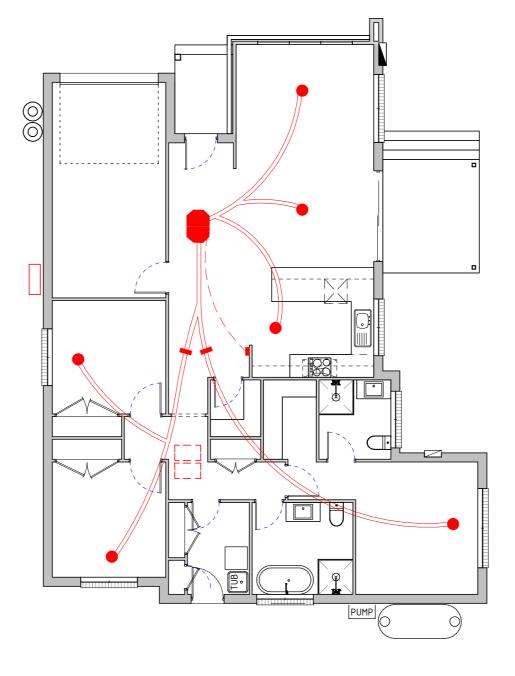
BUILDING DESIGNERS ASSOCIATION OF AUSTRALIA

PROPOSED DUAL OCCUPANCY AT 19 SHEARMAN STREET, CAERLEON (LOT 920)

LYNCH BUILDING DESIGN . CONSTRUCT . DELIVER







 $16 \mid {\substack{\text{DWELLING TWO ELECTRICAL PLAN}\\\text{SCALE: } 1:100 \text{ (A3)}}}$

| DWELLING TWO MECHANICAL PLAN SCALE: 1:100 (A3)

DAY / NIGHT ZONED

ELECTRICAL LEGEND:

300	SINGLE POWER POINT (DISTANCE ABOVE F.F.L)	(4
300	DOUBLE POWER POINT (DISTANCE ABOVE F.F.L)	(1
#	FLUORESCENT LIGHTS - SINGLE	(1
•	DOWN LIGHT	(1
\boxtimes	SENSOR LIGHT	(2
\bigotimes	STANDARD BATTEN	(7
00	TASTIC LIGHT - 4 LIGHT	(1
8	TASTIC LIGHT - 2 LIGHT	(1
™ **	TELEVISION OUTLET	(1
NBN	NBN POINT LOCATION	(1
W/P	EXTERNAL DOUBLE POWER POINT	(2
	LIGHT SWITCH	(1
	MECHANICAL EXHAUST FAN	(0
SA	SMOKE ALARMS	(1

ELECTRICAL NOTES:

- 1. ALL ELECTRICAL WORK SHALL BE CARRIED OUT BY A LICENSED CONTRACTOR. ALL WORK SHALL BE IN ACCORDANCE WITH AS/NZ3012 & ALL LICENSING REQUIREMENTS.
- 2. THE SELECTION OF FITTINGS AND THE LAYOUT TO BE CARRIED OUT BY THE BUILDER & DESIGNED TO THE CLIENTS REQUIREMENTS.
- 3. ALL APPROVED SMOKE ALARMS/DETECTORS TO BE INSTALLED TO AS3786 BY A LICENSED CONTACTOR.

MECHANICAL LEGEND:

OUTDOOR AIR CONDITIONER UNIT

INDOOR SPLIT SYSTEM AIR CONDITIONER UNIT

ZONES

SUPPLY AIR GRILLS - ROUND

RETURN AIR GRILLS

AIR CONDITIONER UNIT IN ROOF SPACE

AIR CONDITIONER CONTROL PANEL / REMOTE

MECHANICAL NOTES:

- 1. ALL MECHANICAL WORKS REGARDING AIR CONDITIONIG SHALL BE CARRIED OUT BY A LICENSED CONSTRACTOR. ALL WORKS SHALL BE IN ACCORDANCE WITH AUS STANDARDS & ALL LICENSING REQUIREMENTS.
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Drawing Title: ELECTRICAL & MECHANICAL PLAN -DWELLING TWO

> Design LBG Sheet 10 of 10 Drawing Number Drawn G.HACKETT

0501 - A10